

# STATE OF HAWAII DEPARTMENT OF LAND AND NATURAL RESOURCES

## ENGINEERING DIVISION

FOR

## **DIVISION OF FORESTRY AND WILDLIFE**

# JOB NO. D00AK67B LIHU'E-KOLOA FOREST RESERVE QUEENSLAND LOOP ROAD LOW WATER CROSSING

# KAUAI, HAWAII

## T.M.K.: 4-4-2-001-002

INDEX

DESCRIPTION	DRAWING NO.	SHEET NO.
TITLE SHEET	T-1	1
CONSTRUCTION NOTES 01	C-01	2
CONSTRUCTION NOTES 02	C-02	3
SITE GRADING PLAN - QUEENSLAND	C-03	4
PLAN AND PROFILE - QUEENSLAND	C-04	5
ROADWAY SECTIONS 01 - QUEENSLAND	C-05	6
ROADWAY DETAILS 01 - QUEENSLAND	C-06	7
PHASE 1 EROSION CONTROL/BMP PLAN - QUEENSLAND	C-07	8
PHASE 2 EROSION CONTROL/BMP PLAN - QUEENSLAND	C-08	9
STRUCTURAL NOTES	S-1	10
TYPICAL DETAILS	S-2	11
QUEENSLAND CROSSING DEMO PLAN	S-3	12
QUEENSLAND CROSSING IMPROVEMENT PLAN VIEW	S-4	13
QUEENSLAND CROSSING PLAN	S-5	14
QUEENSLAND CROSSING ELEV	S-6	15
QUEENSLAND CROSSING SECTIONS	S-7	16
QUEENSLAND CROSSING SECTIONS AND DEBRIS CATCHER DETA	IL S-8	17
WINGWALL SECTIONS	S-9	18

SCOPE OF WORK: WORK SHALL GENERALLY CONSIST OF PROVIDING CONCRETE BOX CULVERTS AND RETAINING WALLS AT THE QUEENSLAND CROSSING. THE CULVERTS AND RETAINING WALLS WILL PREVENT FUTURE WASHOUT DUE TO FLOODING.

**APPROVED:** 

02/14/2024 DATE:

Robert Haup DAVID G. SMIŤ ADMINISTRATOR

DIVISION OF FORESTRY AND WILDLIFE DEPARTMENT OF LAND AND NATURAL RESOURCES

APPROVED:

DATE: 02/14/2024

ARTY S. CHANG, P.E. CHIEF ENGINEER ENGINEERING DIVISION DEPARTMENT OF LAND AND NATURAL RESOURCES

T-1

<u>N0</u>	TES FOR GENERAL CONSTRUCTION	18.	AFTER EACH RAINFALL EVEN SILT AND DEBRIS RESULTING
1.	ALL CONSTRUCTION WORK IS TO BE CONSTRUCTED IN ACCORDANCE WITH THE PUBLICATIONS "HAWAI'I STANDARD SPECIFICATIONS FOR ROAD AND BRIDGE CONSTRUCTION, 2005" AND ITS AMENDMENTS AND THE		DRAINAGE FACILITIES, ROADW INCURRED FOR ANY NECESSA ENGINEER SHALL BE PAYABL
	"STANDARD DETAILS FOR PUBLIC WORKS CONSTRUCTION, SEPTEMBER 1984", AS AMENDED, BY THE DEPARTMENT OF PUBLIC WORKS, CITY AND COUNTY OF HONOLULU AND THE COUNTIES OF KAUA'I, MAUI AND HAWAI'I. THE STANDARD DETAILS ARE AVAILABLE AT THE COUNTY OF KAUA'I CLERK'S OFFICE.	19.	DURING CLEANING OPERATION WATER TRUCK FOR DUST CO HAS RE-ESTABLISHED ITSELF SHALL NOT BE ALLOWED TO
2.	CONSTRUCTION SHALL BE DONE IN SUBSTANTIAL CONFORMANCE WITH GEOTECHNICAL ENGINEERING REPORT "LIHUE-KOLOA FOREST RESERVE QUEENSLAND CROSSING" DATED AUGUST 19, 2021 BY HART CROWSER WHERE APPLICABLE.	20.	BENCHMARKS THAT ARE DIS RESTORED UNDER A LICENSE FIELD NOTES, DESCRIPTIONS SHALL BE SENT TO THE DEF SECTION FOR REVIEW AND A THE PROJECT.
3.	TOPOGRAPHIC INFORMATION OBTAINED FROM "TOPOGRAPHIC MAP SHOWING QUEENSLAND CROSSING" PREPARED BY ESAKI SURVEYING & MAPPING, MAY 4, 2021. THIS TOPOGRAPHIC SURVEY WAS BASED ON THE BEST AVAILABLE INFORMATION AND ACCURACY MUST BE VERIFIED PRIOR TO STARTING CONSTRUCTION.	21.	
4.	ALL COORDINATES, GRIDS AND AZIMUTHS ARE REFERRED TO KEAHUA BRIDGE-KUAMOO ROAD"	22.	DLNR WILL DELEGATE THE C REPRESENTATIVE TO SUBMIT AS REQUIRED BY THE COUN
5.	ELEVATIONS SHOWN ON THE PLANS ARE BASED ON MEAN SEA LEVEL DATUM BENCH MARK IS SHOWN ON SHEET C-04.	23.	AT NO COSTS TO THE STAT
6.	SIGNS SHALL BE INSTALLED IN ACCORDANCE WITH THE STANDARD DETAILS FOR PUBLIC WORKS CONSTRUCTION, COUNTY OF KAUA'I, SEPTEMBER 1984, AND ITS AMENDMENTS.		DRAWINGS PRIOR TO THE ST SHALL BE IMMEDIATELY BRO FOR DIRECTION.
7.	PRIOR TO CONSTRUCTION THE CONTRACTOR SHALL CONTACT THE VARIOUS UTILITY AGENCIES FOR LOCATION OF EXISTING UTILITIES WITHIN THE PROJECT LIMITS. THE CONTRACTOR SHALL LOCATE AND PROTECT ALL EXISTING UTILITIES WHETHER OR NOT SHOWN ON THE PLANS. ANY		AT ALL TIMES DURING PERFO AND COMPLETE RESPONSIBIL ALL PERSONS AND PROPERT
8.	COSTS INCURRED BY DAMAGES TO EXISTING UTILITIES WILL BE BORNE BY THE CONTRACTOR. ALL EXISTING UTILITIES, WHETHER OR NOT SHOWN ON THE PLANS, SHALL	25.	HARD BOULDERS AND MEDIU ENCOUNTERED NEAR OR AT EXCAVATING THE MEDIUM HA REQUIRED.
	BE PROTECTED AT ALL TIMES BY THE CONTRACTOR UNLESS SPECIFIED ON THE PLANS TO BE ABANDONED.	26.	NO BLASTING SHALL BE ALL
9.	WHEREVER CONNECTIONS TO EXISTING UTILITIES ARE SHOWN ON THE PLANS, THE CONTRACTOR SHALL EXPOSE THE EXISTING LINES PRIOR TO EXCAVATION OF THE MAIN TRENCHES TO VERIFY THEIR LOCATION AND		CONSTRUCT TEMPORARY BAI PROTECTION OF LIFE, SAFET
10.	DEPTH. ALL TRAFFIC SIGNS AND PAVEMENT MARKINGS SHALL CONFORM TO THE	28.	THE LIHUE-KOLOA FOREST F CONSTRUCTION PERIOD. PRO SIGNS TO PROTECT THE PUE
11.	MANUAL ON UNIFORM TRAFFIC CONTROL DEVICES FOR STREETS AND HIGHWAYS, CURRENT EDITION. THE CONTRACTOR SHALL MAKE PROPER ARRANGEMENTS FOR THE USE OF UTILITIES SUCH AS ELECTRICITY, WATER, ETC. AND SHALL BE	29.	PROVIDE AND MAINTAIN ALL BARRICADES, MARKERS, CON TAKE NECESSARY PRECAUTION AND SAFETY OF THE PUBLIC
12.	RESPONSIBLE FOR THE PAYMENT OF ALL COSTS RESULTING FROM SUCH USAGE.	30.	EXISTING PEDESTRIAN WALKW CONDITION OR PROVIDE FOR PEDESTRIAN ACCESS ROUTES
	SURVEYOR LICENSED IN THE STATE OF HAWAI'I.		STANDARDS FOR ACCESSIBLI AND ADAAG 206.1.
10.	THE CONTRACTOR SHALL CONTACT THE DEPARTMENT OF LAND AND NATURAL RESOURCES, ENGINEERING DIVISION, INSPECTION SECTION AT LEAST FIVE (5) WORKING DAYS BEFORE COMMENCING ANY WORK ON THE PROJECT. THE CONTRACTOR SHALL HOLD A PRECONSTRUCTION MEETING WITH THE CONSTRUCTION SECTION OF DLNR BEFORE COMMENCING ANY WORK.	31.	NO PERFORMANCE OF ANY OF FALLING ROCKS, SOIL OR DE FLOW ONTO ADJOINING PROF COURSES. SHOULD SUCH VIO ANY REMEDIAL ACTION SHAL
14.	CONTRACTOR SHALL SUBMIT 'AS-BUILT' PLANS WITHIN 14 DAYS AFTER FINAL INSPECTION, INCLUDING STREET MONUMENT DATA (ELEVATIONS & LOCATION) DONE BY A LICENSED SURVEYOR, REGISTERED IN THE STATE OF HAWAI'I.	32.	COORDINATE CONSTRUCTION RELATED CONSTRUCTION AC AVOID DELAY OR HINDRANCE RESPECTIVE CONTRACTS.
15.	IF SYSTEM CONDITIONS REQUIRE NON-EMERGENCY NIGHT TIME WORK DURING THE AUTUMN SEABIRD FALL SEASON (SEPTEMBER 15 THROUGH DECEMBER 15), USE OF LIGHTING SHALL BE RESTRICTED BETWEEN 9:00 PM TO 4:30 AM. IF LIGHTING OF THE WORK AREA IS REQUIRED IN SUCH SITUATION, ALL LIGHTS SHALL BE SHIELDED (MINIMUM LIGHT SPILL TOWARDS THE SKY) AND DIRECTED DOWNWARDS TO THE MAXIMUM EXTENT PRACTICABLE. MINIMUM REQUIREMENTS FOR LIGHTING BY HIOSH AND OSHA SHALL BE PROVIDED AND ASSURED BY THE CONTRACTOR.	33.	THE UNDERGROUND PIPES, O THE ENGINEER FROM HIS SE PLANS. THE CONTRACTOR SE OF THE FACILITIES AND EXEL AREA. ALL DAMAGED PORTION WITH THE STANDARDS AND COMPANY AND SHALL BE THE INJURY RESULTING FROM CO THE CONTRACTORS RESPONSE
	THE CONTRACTOR SHALL TRAIN ALL EMPLOYEES WORKING AT NIGHT (RECORDS RETAINED BY THE CONTRACTOR) IN HOW TO HANDLE ANY RETRIEVED DOWNED BIRDS AND SHALL HAVE APPROPRIATE EQUIPMENT AS APPROVED BY SAVE OUR SHEARWATERS (SOS) ON SITE TO HOLD AND TRANSPORT ANY RETRIEVED BIRDS TO A SOS FACILITY. THIS	34.	WHEREVER CONNECTIONS OF SHOWN ON THE PLANS, THE LINES AT THE PROPOSED CO LOCATIONS AND DEPTHS PRI
	REQUIREMENT DOES NOT ALLOW LIGHTING AS MAY BE RESTRICTED BY OTHER GOVERNMENT AGENCIES.	35.	NOTIFY ALL AGENCIES AND LOCATION OF ALL SITE UTILI EXCAVATION.
16.	THE CONTRACTOR SHALL BE RESPONSIBLE FOR ALL OVERTIME AND/OR NIGHT WORK PAYMENTS FOR COUNTY'S STAFF INSPECTION PERSONNEL INCLUDING CONSULTANTS WHEN THE CONTRACT REQUIRES OVERTIME OR NIGHT WORK TO BE PERFORMED, OR DIRECTS THE CONTRACTOR TO WORK ADDITIONAL SHIFTS OR OVERTIME FOR COUNTY'S CONVENIENCE.	36.	NOTIFY AND COORDINATE AL AT (866) 423–7287 AT LEA OF EXCAVATION OR TRENCH
17.	ALL GRADING, GRUBBING AND STOCKPILING WORK SHALL BE PERFORMED IN ACCORDANCE WITH COUNTY OF KAUA'I ORDINANCE NO. 808.		

L EVENT, THE CONTRACTOR SHALL REMOVE ALL SULTING FROM HIS WORK AND DEPOSITED IN ROADWAYS, AND OTHER AREAS. THE COST RECESSARY REMEDIAL ACTION BY THE COUNTY PAYABLE BY THE CONTRACTOR.

ERATIONS, THE CONTRACTOR SHALL SUPPLY A UST CONTROL PURPOSES UNTIL THE VEGETATION ) ITSELF. EXCESS WATER, INCLUDING SILT AND DIRT, WED TO RUN-OFF THE PROPERTY.

RE DISTURBED OR DESTROYED SHALL BE LICENSED LAND SURVEYOR'S DIRECTION. COPIES OF PTIONS AND NEW VALUES OF THE NEW BENCHMARK THE DEPARTMENT OF PUBLIC WORKS SURVEY AND APPROVAL PRIOR TO FINAL ACCEPTANCE OF

RACTICES (BMP'S) SHALL BE EMPLOYED AT ALL UM EXTENT PRACTICABLE TO PREVENT DAMAGE BY SION OR DUST TO STREAMS, WATERCOURSES, THE PROPERTY OF OTHERS.

THE CONTRACTOR AS THE AUTHORIZED SUBMIT ALL NECESSARY DOCUMENTS AND REPORTS COUNTY AND DOH DIRECTLY TO THEIR OFFICES STATE.

LL DIMENSIONS AND DETAILS SHOWN ON THE THE START OF CONSTRUCTION. ANY DISCREPANCY Y BROUGHT TO THE ATTENTION OF THE ENGINEER

G PERFORMANCE OF THIS CONTRACT, ASSUME SOLE ONSIBILITY FOR THE SITE SAFETY CONDITIONS FOR ROPERTY.

MEDIUM HARD TO HARD BASALT ROCK MAY BE OR AT THE SITE. APPROPRIATE EQUIPMENT FOR NUM HARD TO HARD BASALT ROCK SHALL BE

BE ALLOWED ON THIS PROJECT.

RY BARRICADES DURING CONSTRUCTION, FOR THE SAFETY, AND PROPERTY.

DREST RESERVE SHALL REMAIN OPEN DURING THE D. PROVIDE TEMPORARY BARRICADES AND WARNING HE PUBLIC DURING THE CONSTRUCTION PERIOD.

IN ALL NECESSARY SIGNS, LIGHTS, FLARES, RS, CONES AND OTHER PROTECTIVE FACILITIES AND ECAUTIONS FOR THE PROTECTION, CONVENIENCE

WALKWAYS SHALL BE MAINTAINED IN A PASSABLE DE FOR ALTERNATE/TEMPORARY ACCESSIBLE ROUTES AND FACILITIES PER THE 2010 ADA ESSIBLE DESIGN CHAPTER 2 AND ADAAG 201.3

ANY CONSTRUCTION OPERATION SO AS TO CAUSE OR DEBRIS IN ANY FORM TO FALL, SLIDE OR G PROPERTIES, STREETS OR NATURAL WATER JCH VIOLATIONS OCCUR, THE COSTS INCURRED FOR N SHALL BE PAYABLE BY THE CONTRACTOR.

JCTION ACTIVITIES WITH ANY ADJACENT OR ON ACTIVITIES ON ANOTHER CONSTRUCTION SITE. DRANCE IN THE PERFORMANCE OF THEIR

PIPES, CABLES OR DUCTLINES KNOWN TO EXIST BY HIS SEARCH OF RECORDS ARE INDICATED ON THE CTOR SHALL VERIFY THE LOCATIONS AND DEPTHS ND EXERCISE PROPER CARE IN EXCAVATING IN THE PORTIONS SHALL BE REPLACED IN ACCORDANCE S AND SPECIFICATIONS OF THE AFFECTED UTILITY BE THE CONTRACTORS RESPONSIBILITY. PERSONAL ROM CONTACT WITH EXISTING UTILITIES SHALL BE ESPONSIBILITY.

ONS OF NEW UTILITIES TO EXISTING UTILITIES ARE IS, THE CONTRACTOR SHALL EXPOSE THE EXISTING SED CONNECTION POINT TO VERIFY THEIR THS PRIOR TO EXCAVATION FOR NEW LINES.

AND UTILITY COMPANIES TO VERIFY THE ACTUAL E UTILITIES IN THE PROJECT AREA PRIOR TO

ATE ALL SITE WORK WITH THE ONE CALL CENTER AT LEAST 5 WORKING DAYS PRIOR TO THE START RENCHING.

- 37. IF WATER, SEWAGE, OR ELECTRICAL SERVICES ARE PLANNED TO BE INTERRUPTED FOR MORE THAN 1 HOUR, PROVIDE TEMPORARY WATER, SEWAGE, AND ELECTRICAL SERVICES DURING THE INTERRUPTION AT NO ADDITIONAL COST TO THE STATE.
- 38. ADJUST MANHOLE AND/OR VALVE BOX FRAMES AND COVERS AS REQUIRED BY THE UTILITY COMPANIES.
- 39. CONFORM WITH THE APPLICABLE PROVISIONS OF CHAPTER 54, WATER QUALITY STANDARDS, AND CHAPTER 55, WATER POLLUTION CONTROL, OF TITLE 11, HAWAII ADMINISTRATIVE RULES OF THE STATE DEPARTMENT OF HEALTH.
- 40. OBTAIN AND PAY FOR ALL REQUIRED PERMITS FROM THE APPROPRIATE GOVERNMENT AGENCIES.
- 41. RESTORE ALL AREAS DISTURBED AS A RESULT OF ALL CONSTRUCTION ACTIVITIES, TO EQUAL OR BETTER CONDITION(S), INCLUDING BUT NOT LIMITED TO VEGETATION, PAVEMENTS, EMBANKMENTS, CURBS, SIGNS, LANDSCAPING, STRUCTURES, UTILITIES, WALKWAYS, FENCES, ETC. UNLESS SPECIFICALLY NOTED OTHERWISE.
- 42. IF ONE (1) OR MORE ACRE OF LAND IS DISTURBED, DO NOT START GROUND DISTURBANCE UNTIL A NPDES PERMIT IS OBTAINED FROM THE DEPARTMENT OF HEALTH, STATE OF HAWAII, AND HAS SATISFIED ALL OTHER APPLICABLE REQUIREMENTS OF THE NPDES PERMIT PROGRAM. ALSO, FOR COUNTY PROJECTS, PROVIDE A WRITTEN COPY OF THE NPDES PERMIT TO THE APPROPRIATE COUNTY OR GOVERNMENTAL AGENCY PER THEIR REQUIREMENTS.
- 43. ALL STRIPING SHALL BE A THERMOPLASTIC TYPE.
- 44. PROVIDE THEFT-RESISTANT FASTENERS FOR ALL ACCESSORY MOUNTINGS. ALL FASTENERS SHALL BE STAINLESS STEEL WITH THEFT-RESISTANT TYPE HEADS OR NUTS.
- 45. PROVIDE ALL INCIDENTAL AND NECESSARY WORK TO COMPLETE THE PROJECT.
- 46. THE JOB SITE SHALL BE LEFT IN A SAFE, SECURE CONDITION AT THE END OF EACH CONSTRUCTION WORKDAY. CLEAN UP AND REMOVE, FROM THE JOB SITE, ALL RUBBISH AND MAINTAIN THE PREMISES IN A CLEAN ORDERLY CONDITION AT ALL TIMES.
- 47. UPON COMPLETION OF CONSTRUCTION THE ENTIRE JOB SITE SHALL BE CLEANED OF ALL RUBBISH AND DEBRIS.

#### HISTORICAL PRESERVATION NOTES

1. SHOULD HISTORIC REMAINS SUCH AS ARTIFACTS, BURIALS, CONCENTRATION OF SHELL OR CHARCOAL BE ENCOUNTERED DURING CONSTRUCTION ACTIVITIES, WORK SHALL CEASE IMMEDIATELY IN THE IMMEDIATE VICINITY OF THE FIND AND THE FIND SHALL BE PROTECTED FROM FURTHER DAMAGE. THE CONTRACTOR SHALL CORDON OFF THE AREA AND IMMEDIATELY NOTIFY THE STATE HISTORIC PRESERVATION DIVISION AT (808) 692-8015, WHICH WILL ASSESS THE SIGNIFICANCE OF THE FIND AND RECOMMEND THE APPROPRIATE MITIGATION MEASURES, IF NECESSARY. IN ADDITION, IF HUMAN BURIALS ARE FOUND, THE CONTRACTOR SHALL IMMEDIATELY NOTIFY THE COUNTY OF KAUA'I POLICE DEPARTMENT.

#### WATER POLLUTION AND EROSION CONTROL NOTES

- 1. GENERAL:
- A. THE CONTRACTOR IS REMINDED OF THE REQUIREMENTS OF SECTION 209-WATER POLLUTION AND EROSION CONTROL AND SECTION 620-DUST CONTROL, IN THE "HAWAII STANDARD SPECIFICATIONS FOR ROAD AND BRIDGE CONSTRUCTION, 2005" AND ITS AMENDMENTS. SECTION 209 DESCRIBES BUT IS NOT LIMITED TO: SUBMITTAL REQUIREMENTS; CONSTRUCTION REQUIREMENTS; METHOD OF MEASUREMENT; AND BASIS OF PAYMENT.
- B. THE CONTRACTOR SHALL FOLLOW THE GUIDELINES IN THE "INTERIM BEST MANAGEMENT PRACTICES MANUAL FOR CONSTRUCTION SITES FOR COUNTY OF KAUA'I" IN DEVELOPING, INSTALLING AND MAINTAINING THE BEST MANAGEMENT PRACTICES (BMPS) FOR THE PROJECT. THE CONTRACTOR MAY SUBMIT ALTERNATE METHODS TO THE COUNTY FOR ACCEPTANCE.
- C. THE CONTRACTOR SHALL KEEP A COPY OF THE APPROVED BMP PLAN, NOI, ETC. ON THE PROJECT SITE. THE BMP PLAN SHALL BE UPDATED TO REFLECT ANY CHANGES MADE DURING THE COURSE OF CONSTRUCTION FOR THE DURATION OF THE PROJECT.
- D. THE CONTRACTOR, AT THE CONTRACTOR'S EXPENSE, WILL BE RESPONSIBLE FOR ALL FINES OR PENALTIES FOR NONCOMPLIANCE TO ENVIRONMENTAL LAWS, INCLUDING BUT NOT LIMITED TO, THE CLEAN WATER ACT, CLEAN AIR ACT, NPDES, ETC. THERE IS NO MAXIMUM LIMIT ON THE AMOUNT ASSESSED PER DAY. THE STATE WILL NOT REIMBURSE THE CONTRACTOR FOR FINES AND/OR PENALTIES INCURRED.
- E. THE DLNR MAY DEDUCT THE COST FROM THE PROGRESS PAYMENT FOR ALL CITATIONS RECEIVED BY THE DEPARTMENT FOR NON-COMPLIANCE, OR THE CONTRACTOR/OWNER SHALL REIMBURSE THE STATE AND/OR COUNTY FOR THE FULL AMOUNT OF THE OUTSTANDING COST INCURRED BY THE STATE AND/OR COUNTY.

#### 2. WASTE DISPOSAL:

- A. WASTE MATERIALS: ALL WASTE MATERIALS SHALL BE COLLECTED AND STORED IN A SECURELY LIDDED METAL DUMPSTER THAT DOES NOT LEAK. THE DUMPSTER SHALL MEET ALL LOCAL AND STATE SOLID WASTE MANAGEMENT REGULATIONS. ALL TRASH AND CONSTRUCTION DEBRIS FROM THE SITE SHALL BE DEPOSITED IN THE DUMPSTER. THE DUMPSTER SHALL BE EMPTIED A MINIMUM OF TWICE PER WEEK OR AS OFTEN AS IS DEEMED NECESSARY. NO CONSTRUCTION WASTE MATERIAL SHALL BE BURIED ONSITE. THE CONTRACTOR'S SUPERVISORY PERSONNEL SHALL BE INSTRUCTED REGARDING THE CORRECT PROCEDURE FOR WASTE DISPOSAL. NOTICES STATING THESE PRACTICES SHALL BE POSTED IN THE OFFICE TRAILER AND THE CONTRACTOR SHALL BE RESPONSIBLE FOR SEEING THAT THESE PROCEDURES ARE FOLLOWED.
- B. HAZARDOUS WASTE: ALL HAZARDOUS WASTE MATERIAL SHALL BE DISPOSED OF IN THE MANNER SPECIFIED BY LOCAL OR STATE REGULATIONS OR BY THE MANUFACTURER. THE CONTRACTOR'S SITE PERSONNEL SHALL BE INSTRUCTED IN THESE PRACTICES AND SHALL BE RESPONSIBLE FOR SEEING THAT THESE PRACTICES FOR FOLLOWED.
- C. SANITARY WASTE: ALL SANITARY WASTE SHALL BE COLLECTED FROM THE PORTABLE UNITS A MINIMUM OF ONCE PER WEEK, OR AS REQUIRED.

3. EROSION AND SEDIMENT CONTROL INSPECTION AND MAINTENANCE PRACTICES:

- A. ALL CONTROL MEASURES SHALL BE INSPECTED AT LEAST ONCE EACH WEEK AND WITHIN 24 HOURS FOLLOWING ANY RAINFALL EVENT OF 0.5 INCHES OR GREATER.
- B. ALL MEASURES SHALL BE MAINTAINED IN GOOD WORKING ORDER. IF REPAIR IS NECESSARY, IT SHALL BE INITIATED WITHIN 24 HOURS AFTER THE INSPECTION.
- C. BUILT UP SEDIMENT SHALL BE REMOVED FROM SILT FENCE WHEN IT HAS REACHED ONE-THIRD THE HEIGHT OF THE FENCE.
- D. SILT SCREEN OF FENCE SHALL BE INSPECTED FOR DEPTH OF SEDIMENT, TEARS, TO VERY THAT THE FABRIC FENCE IS SECURELY ATTACHED TO THE FENCE POST OR CONCRETE SLAB AND TO VERIFY THAT THE FENCE POST ARE FIRMLY IN THE GROUND
- E. TEMPORARY AND PERMANENT SEEDING AND PLANTING SHALL BE INSPECTED FOR BARE SPOTS, WASH OUTS AND HEALTHY GROWTH.
- F. THE CONTRACTOR SHALL SUBMIT TO THE ENGINEER A MAINTENANCE INSPECTION REPORT PROMPTLY AFTER EACH WEEKLY INSPECTION.
- G. THE CONTRACTOR SHALL SELECT A MINIMUM OF THREE PERSONNEL WHO SHALL BE RESPONSIBLE FOR INSPECTIONS, MAINTENANCE AND REPAIR ACTIVITIES AND FILLING OUT THE INSPECTION AND MAINTENANCE REPORT.
- H. PERSONNEL SELECTED FOR THE INSPECTION AND MAINTENANCE RESPONSIBILITIES SHALL RECEIVE TRAINING FROM THE CONTRACTOR. THEY SHALL BE TRAINED IN ALL THE INSPECTION AND MAINTENANCE PRACTICES NECESSARY FOR KEEPING THE EROSION AND SEDIMENT CONTROLS USED ONSITE IN GOOD WORKING ORDER.
- I. ALL SLOPES AND EXPOSED AREAS SHALL BE GRASSED AS FINAL GRADES HAVE BEEN ESTABLISHED. GRADING TO FINAL GRADE SHALL BE CONTINUOUS, AND ANY AREA IN WHICH WORK HAS BEEN INTERRUPTED OR DELAYED OR EXPOSED FOR MORE THAN 15 DAYS SHALL BE GRASSED IN ORDER TO PREVENT DUST EMISSION, EROSION AND SILT RUNOFF. AREAS WITH IMPORTED SOILS SHALL BE GRASSED NOT MORE THAN 5 WORKING DAYS AFTER THE FINAL GRADES HAVE BEEN ESTABLISHED.
- J. TEMPORARY EROSION CONTROLS SHALL NOT BE REMOVED BEFORE PERMANENT EROSION CONTROLS ARE IN-PLACE AND ESTABLISHED.

REVISION NO.	SYM.		DESCRIPTION	SHT./OF	DATE	APPROVED		
AKINAKA & ASSOCIATES, LTD.		·	STATE OF HAWAII DEPARTMENT OF LAND AND NATURAL RESOURCES ENGINEERING DIVISION					
			LIHUE-KOLOA FOREST RESERVE QUEENSLAND LOOP ROAD LOW WATER CROSSING					
	No. 9	148-C , U.S. F.	CONSTRUCTION NOTES 01					
		,		6		Ś		
	/	. / .	DESIGNED: GMG	SUBMITTE	D:			
K	m C	Kar	DRAWN: KJM/AKK	DATE: FEE	3 2024			
		1	CHECKED: KCK	SCALE: AS	SHOWN			
			APPR Carty Chang		DR,	AWING NO.		
EXPIRATION DATE OF THE LICENSE 4/30/2024 THIS WORK WAS PREPARED BY ME OR UNDER MY SUPERVISION		S PREPARED BY	E-signed 2024-02-14 09:55AM HST carty.s.chang@hawaii.gov CHIEI State of Hawaii	DATE		C-01		
	JOB I	NO. D00AK67B	Chief Engineer SHEET NO.	2 <b>OF</b>	18 SHE	ETS		

Λ	ER POLLUTION AND EROSION CONTROL NOTES (CON'T)		CLEARLY PO CLEANUP. M THE LOCATIO
	GOOD HOUSE KEEPING BEST MANAGEMENT PRACTICES:		d. KEEP MATER
	1. APPLICABLE MATERIALS OR SUBSTANCES LISTED BELOW ARE EXPECTED		THE MATERIA CLEAN UP A
	TO BE PRESENT ONSITE DURING CONSTRUCTION. OTHER MATERIALS AND SUBSTANCES NOT LISTED BELOW SHALL BE ADDED TO THE INVENTORY OF THE CONSTRUCTION CONTRACTOR'S SITE-SPECIFIC BMP PLAN.		
	CONCRETE FERTILIZERS DETERGENTS PETROLEUM BASED PRODUCTS PAINTS (ENAMEL & LATEX) CLEANING SOLVENTS METAL STUDS WOOD		
	METAL STUDS WOOD TAR MASONRY BLOCK	<u>SE'</u>	VERE STORM
	D. MATERIAL MANAGEMENT SHALL BE USED TO REDUCE THE RISK OF SPILLS OR OTHER ACCIDENTAL EXPOSURE OF MATERIALS AND SUBSTANCES TO STORM WATER RUNOFF. AN EFFORT SHALL BE MADE TO STORE ONLY ENOUGH PRODUCT AS IS REQUIRED TO DO THE JOB.	Α.	
	2. ALL MATERIALS STORED ONSITE SHALL BE STORED IN A NEAT, ORDERLY MANNER IN THEIR APPROPRIATE CONTAINERS AND IF POSSIBLE UNDER A ROOF OR OTHER ENCLOSURE.		THEM TO PREV WATER OR HIGH CONCERN THAT
	. PRODUCTS SHALL BE KEPT IN THEIR ORIGINAL CONTAINERS WITH THE ORIGINAL MANUFACTURER'S LABEL.	В.	INSPECT THE S WHERE PRACTION WILL OTHERWIS CLEAR ANY DE
	e. SUBSTANCES SHALL NOT BE MIXED WITH ONE ANOTHER UNLESS RECOMMENDED BY THE MANUFACTURER.		FLOODING RISK REMOVE BMPS
	. A PRODUCT SHALL BE USED UP COMPLETELY BEFORE DISPOSING OF THE CONTAINER.		THE SEVERE WINCLUDES HIGH BECOME AIRBO
	g. MANUFACTURER'S RECOMMENDATION FOR PROPER USE AND DISPOSAL SHALL BE FOLLOWED.		CONCERN, BMP
	N. THE CONTRACTOR SHALL CONDUCT A DAILY INSPECTION TO ENSURE PROPER USE AND DISPOSAL OF MATERIALS ONSITE.	D.	SECURE, COVER BECOME MOBILI
В.	AZARDOUS MATERIAL POLLUTION PREVENTION PLAN:	E.	SECURE, COVER BECOME MOBILI
	2. PRODUCTS SHALL BE KEPT IN THEIR ORIGINAL CONTAINERS UNLESS THEY ARE NOT RESEALABLE.		PARTICULAR, E OR STORED INE
	<ul> <li>ORIGINAL LABELS AND MATERIALS SAFETY DATA SHEETS MSDS SHALL</li> <li>BE RETAINED AND MADE AVAILABLE TO THE COUNTY ENGINEER UPON REQUEST.</li> <li>SURPLUS PRODUCTS SHALL BE DISPOSED OF ACCORDING TO</li> </ul>		CLEAR ANY DR OR BUILT-UP S STORM WATER INLET PROTECT BE REASONABL
	MANUFACTURER'S INSTRUCTIONS OR LOCAL AND STATE RECOMMENDED REGULATIONS.		FLOODING, ERO IMPROVE AND CONCERN, INLE POSSIBLE.
C.	ONSITE AND OFFSITE PRODUCTS SPECIFIC PLANS:	$\sim$	
ONS		G.	TEMPORARILY S FEASIBLE), TO WATERS.
	D. PETROLEUM BASED PRODUCTS: ALL ONSITE VEHICLES SHALL BE MONITORED FOR LEAKS AND RECEIVE REGULAR PREVENTIVE MAINTENANCE TO REDUCE THE CHANCE OF LEAKAGE. PETROLEUM	PEI	RMIT REQUIR
	DRODUCTS SHALL BE STORED IN TICHTLY SEALED CONTAINERS WHICH		THE CONTRACT AND EROSION ( OF THE SPECIF HAS BEEN REV
	RECOMMENDED BY THE MANUFACTURER. ONCE APPLIED, WORK FERTILIZER INTO THE SOIL TO LIMIT EXPOSURE TO STORM WATER.		THE CONTRACT FEDERAL PERM
		3.	PERMITS MAY I
	2. PAINTS: SEAL AND STORE ALL CONTAINER WHEN NOT REQUIRED FOR USE. DO NOT DISCHARGE EXCESS PAINT TO THE ROADWAY DRAINAGE		U.S. DEPARTME
	SYSTEM. DISPOSE PROPERLY ACCORDING TO MANUFACTURER'S INSTRUCTION OR STATE AND LOCAL REGULATIONS.		WATER QUALITY
	. CONCRETE TRUCKS: WASH OUT OR DISCHARGE CONCRETE TRUCK DRUM WASH WATER ONLY AT A DESIGNATED SITE. DO NOT DISCHARGE WATER 2		COASTAL ZONE
	IN ROADWAY DRAINAGE SYSTEM OR WATERS OF THE UNITED STATES. CONTACT DRINKING WATER BRANCH, DEPARTMENT OF HEALTH AT (808)		THE CONTRACT
	586-4258 TO RECEIVE PERMISSION TO DESIGNATE A DISPOSAL SITE. CLEAN DISPOSAL SITE AS REQUIRED OR AS REQUESTED BY THE OWNER'S REPRESENTATIVE.		PROVIDING ANY PERMIT PROCES PLAN AND QUE PROCESS/METH
D.	SPILL CONTROL PLAN:	Β.	HANDLING ANY EQUIPMENT ANI
	a. POST A SPILL PREVENTION PLAN TO INCLUDE MEASURES TO PREVENT AND CLEAN UP EACH SPILLWAY.	5.	ON THIS JOB.
	THE CONTRACTOR SHALL BE THE SPILL PREVENTION AND CLEANUP COORDINATOR. DESIGNATE AT LEAST THREE SITE PERSONNEL WHO SHALL RECEIVE SPILL PREVENTION AND CLEANUP TRAINING. THESE INDIVIDUALS SHALL EACH BECOME RESPONSIBLE FOR A PARTICULAR PHASE OF PREVENTION AND CLEANUP. POST THE NAMES OF RESPONSIBLE SPILL PERSONAL IN THE MATERIAL STORAGE AREA AND IN	J.	ADDITIONAL CO NOTICE OF INTE WATER AND/OF DISCHARGE HYI WATERS. ACCO THE SITE SPEC

OST MANUFACTURER'S RECOMMENDED METHODS FOR SPILL MAKE SITE PERSONNEL AWARE OF THE PROCEDURES AND ION OF INFORMATION AND CLEANUP SUPPLIES.

- RIALS AND EQUIPMENT NECESSARY FOR SPILL CLEANUP IN RIAL STORAGE AREA ONSITE.
- ALL SPILL IMMEDIATELY AFTER DISCOVERY.
- SPILL AREA WELL VENTILATED. PERSONNEL SHALL WEAR TE PROTECTIVE CLOTHING TO PREVENT INJURY FROM WITH HAZARDOUS SUBSTANCE.
- PILLS OF TOXIC HAZARDOUS MATERIAL TO THE APPROPRIATE LOCAL GOVERNMENT AGENCY, REGARDLESS OF THE SIZE.

#### M PREPAREDNESS NOTES

- CONSTRUCTION SITE BY TAKING THE FOLLOWING STEPS:
- ITE OF ANY CONSTRUCTION DEBRIS OR TRASH THAT MAY LIZED BY STORM WATER OR HIGH WINDS. SECURE ALL N-SITE BY STORING THEM INDOORS OR SECURELY COVERING VENT STORED DEBRIS FROM BEING MOBILIZED BY STORM GH WINDS. PHYSICALLY SECURE THE DUMPSTER IF THERE IS AT THE DUMPSTER ITSELF MAY BY MOBILIZED BY HIGH WINDS.
- SITE'S BMPS FOR THEIR CONDITION PRIOR TO THE STORM. FICAL, REPAIR OR REPLACE BMP'S THAT ARE DAMAGED OR SE NOT PERFORM PROPERLY DURING THE STORM EVENT EBRIS OR ACCUMULATED SEDIMENT ON ANY BMP TO REDUCE
- IF THEY MAY CAUSE LOSS OF LIFE AND PROPERTY DURING WEATHER EVENT. FOR EXAMPLE, IF THE SEVERE WEATHER H WINDS, REMOVE ANY NON-CRITICAL BMPS THAT MAY ORNE AND POSE A RISK TO PROPERTY OR PEOPLE. ONCE MPROVE AND SAFETY OR PROPERTY LOSS IS NO LONGER A PS MUST BE REINSTALLED AS SOON AS POSSIBLE.
- ER, OR REMOVE STOCKPILES OF MATERIALS THAT MAY LIZED BY EITHER STORM WATER OR HIGH WINDS
- ER, OR REMOVE ANY OTHER SITE MATERIALS THAT MAY LIZED BY EITHER STORM WATER OR HIGH WINDS. IN ENSURE THAT ALL CONTAINERS ARE ADEQUATELY SEALED NDOORS TO PREVENT ANY SPILLS TO THE ENVIRONMENT.
- RAINAGE INLETS AND DRAINAGE SYSTEMS OF ANY DEBRIS SEDIMENT TO ENSURE THAT THEY WILL ALLOW ADEQUATE FLOW TO REDUCE THE RISK OF FLOODING. REMOVE DRAIN TION AFTER CLEARING ANY DEBRIS OR SEDIMENT IF IT CAN BLY ASSUMED THAT IT WOULD INCREASE THE RISK OF OSION, OR LOSS OF PROPERTY OR LIFE. ONCE CONDITIONS SAFETY, PROPERTY LOSS, OR EROSION IS NO LONGER A ET PROTECTION MUST BE REINSTALLED AS SOON AS
- STABILIZE OR COVER EXPOSED SOIL AREAS AT THE SITE (IF PREVENT EROSION AND DISCHARGE OF SEDIMENT TO STATE

## REMENTS

- TOR SHALL SUBMIT TO THE ENGINEER THE WATER POLLUTION CONTROL SUBMITTALS AS DETAILED IN SUBSECTION 209.04 IFICATIONS. NO WORK SHALL BEGIN UNTIL THE SUBMITTAL VIEWED AND APPROVED BY THE ENGINEER.
- TOR SHALL COMPLY WITH ALL APPLICABLE STATE AND MIT CONDITIONS.
- INCLUDE BUT ARE NOT LIMITED TO THE FOLLOWING:
- MENT OF THE ARMY PERMIT
- TY CERTIFICATION
- NE MANAGEMENT (CZM) FEDERAL CONSISTENCY CERTIFICATION
- TOR SHALL BE RESPONSIBLE FOR:
- IY ADDITIONAL INFORMATION REQUIRED TO COMPLETE THE ESS, INCLUDING BUT NOT LIMITED TO THE SITE-SPECIFIC BMP JESTIONS REGARDING THE CONSTRUCTION THODOLOGY, AND
- Y REVISIONS REQUIRED TO ADDRESS THE CONSTRUCTION ND METHODOLOGY PROPOSED BY THE CONTRACTOR FOR USE
- TOR, AT THE CONTRACTOR'S OWN EXPENSE AND WITH NO OST TO THE STATE, SHALL APPLY FOR AND OBTAIN NPDES TENT (NOI) FOR DISCHARGES ASSOCIATED WITH HYDROTEST OR DEWATERING SHOULD THE CONTRACTOR ELECT TO YDROTEST AND/OR DEWATERING EFFLUENT INTO STATE ORDINGLY, THE CONTRACTOR SHALL APPLY FOR AND OBTAIN CIFIC NPDES PERMIT FOR THE SUBJECT ACTIVITIES.

- 6. THE CONTRACTOR, AT THE CONTRACTOR'S OWN EXPENSE AND WITH NO ADDITIONAL COST TO THE STATE, SHALL APPLY FOR A DOH NOISE VARIANCE SHOULD THE CONTRACTOR ELECT, AND DLNR APPROVES, TO WORK OUTSIDE OF NORMAL WORKING HOURS.
- 7. THE CONTRACTOR SHALL BE RESPONSIBLE FOR CONFORMANCE WITH T APPLICABLE PROVISIONS OF CHAPTER 54, WATER QUALITY STANDARDS AND CHAPTER 55, WATER POLLUTION CONTROL OF HAR TITLE 11, OF STATE DEPARTMENT OF HEALTH.
- 8. THE CONTRACTOR, AT THE CONTRACTOR'S OWN EXPENSE, SHALL KEEF THE PROJECT AREA AND SURROUNDING AREAS FREE FROM DUST NUISANCE AND ANY MATERIAL TRACKED ON TO THE ROADWAYS. THE WORK SHALL BE CONFORMANCE WITH THE AIR AND WATER POLLUTION CONTROL STANDARDS AND REGULATIONS OF THE STATE DEPARTMENT HEALTH.

### PAVEMENT AND TRENCH RESTORATION NOTES

- 1. PAVEMENT RESURFACING WORK SHALL INCLUDE 2-INCH THICKNESS OF EXISTING A.C. TO BE COLD PLANED AND CONSTRUCTION OF A MINIMUM 2-INCH OF NEW A.C. (STATE MIX IV) LAYER.
- ALL EXISTING PAVEMENT STRIPING DISTURBED BY THIS PROJECT SHAL RESTORED. THE STRIPING MATERIALS SHALL BE THERMOPLASTIC TAPE THERMOPLASTIC EXTRUSION. PAINTING IS NOT ACCEPTABLE.

#### ADDITIONAL DOFAW NOTES

- TAKE ALL MEASURES TO MINIMIZE DISTURBANCE OR DAMAGING EXISTIN NATIVE PLANT SPECIES DURING CONSTRUCTION. DOFAW WILL CONDUC BIOLOGICAL SURVEY OF ENTIRE PROJECT AREA (STAGING AND CONSTRUCTION) PRIOR TO CONTRACTOR STARTING WORK.
- 2. PRIOR TO ENTERING THE JOB SITE, ALL EQUIPMENT AND FOOTWEAR MI BE WASHED WITH POTABLE WATER AND SPRAYED WITH 70% ALCOHOL FRESH 10% CLOROX SOLUTION TO PREVENT EXOTIC PLANTS AND SEED FROM BEING INTRODUCED TO THE JOB SITE/AREA.
- 3. HAWAIIAN HOARY BATS OR 'OPE'APE'A (LASIURUS CINEREUS SEMOTUS) KNOWN TO RESIDE IN THE VICINITY OF THE PROJECT AREA AND MAY ROOST IN NEARBY TREES. ANY SITE CLEARING REQUIRED MUST BE T TO AVOID DISTURBING THE BAT'S BIRTHING AND PUP REARING SEASON (JUNE 1 THROUGH SEPTEMBER 15). IF THIS CANNOT BE AVOIDED, WC PLANTS GREATER THAN 15 FEET (4.6 METERS) IN HEIGHT MUST NOT DISTURBED, REMOVED, OR TRIMMED WITHOUT CONSULTING DOFAW AND STATE'S CONSTRUCTION REPRESENTATIVE. BARBED WIRE IS NOT ALLC BECAUSE BAT MORTALITIES HAVE BEEN DOCUMENTED BY ENSNAREMEN DURING FLIGHT.
- 4. NIGHT WORK THAT REQUIRES OUTDOOR LIGHTING MUST NOT BE CONDUCTED DURING THE SEABIRD FLEDGING SEASON FROM SEPTEMBER THROUGH DECEMBER 15. THIS IS THE PERIOD WHEN YOUNG SEABIRDS TAKE THEIR MAIDEN VOYAGE TO THE OPEN SEA. ARTIFICIAL LIGHTING CAN ADVERSELY IMPACT SEABIRDS BY CAUSING DISORIENTATION. THI DISORIENTATION CAN RESULT IN COLLISION WITH MANMADE ARTIFACTS GROUNDING OF BIRDS. FOR NIGHT LIGHTING THAT MIGHT BE REQUIRE DOFAW REQUIRES THAT ALL LIGHTS BE FULLY SHIELDED TO MINIMIZE IMPACTS.
- 5. THE ACTIVITIES ARE OCCURRING IN A STATE FOREST RESERVE AND THEREFORE ARE SUBJECT TO AND EXPECTED TO FOLLOW ALL PERTINE CHAPTER 104 DOFAW-HAR THAT HAVE BEEN UPDATED IN JANUARY 20 http://dlnr.hawaii.gov/dofaw/files/2013/09/HARChapter13-104.pdf
- 6. STATE LANDS UNDER THE JURISDICTION OF DOFAW ARE OPEN TO PUB HUNTING THROUGHOUT THE YEAR. PLEASE VIEW THE HUNTING RULES AND DAYS ON OUR AGENCY WEBSITE. BLAZE ORANGE SHALL BE WOR ON ALL LEGAL HUNTING DAYS. http://dlnr.hawaii.gov/recreation/hunting/kauai/
- 7. IN THE EVENT ANY ARCHAEOLOGICAL SITES OR REMAINS SUCH AS BO OR CHARCOAL DEPOSITS, HUMAN BURIALS, ROCK OR CORAL ALIGNMEN ROCK WALLS ARE ENCOUNTERED, CONTRACTOR SHALL STOP ALL ACTI AND CONTACT STATE HISTORIC PRESERVATION DIVISION IN KAPOLEI (8) 692-8015 OR SHERI MANN (808) 729-0714 IMMEDIATELY.
- 8. REPORTING OF INAPPROPRIATE ACTIVITIES TO DOFAW AND/OR DOCARE ENCOURAGED. DOCARE HOTLINE (808) 643-DLNR

### ADDITIONAL NOTES RELATING HAWAII EXPERIMENTAL TROPICAL FOREST (H.E.T.F. BIOSECURITY MEASURES (SUCH AS RAPID OF DEATH, (VERIFY WTIH DOFAW ON APPLICABILILTY))

WITH REFERENCE TO THE H.E.T.F. BIOSECURITY HANDOUT, (WHICH IS AVAILABLE FROM D.O.F.A.W. STAFF) COMPLY WITH THE FOLLOWING PARAPHRASED INSTRUCTIONS TO PREVENT THE INTRODUCTION AND SPREA OF HARMFUL ORGANISMS INCLUDING, BUT NOT LIMITED TO WEEDS, INSECT AND INFECTED PLANTS.


1. INSPECT AND CLEAN ALL EQUIPMENT, GEAR, AND VEHICLES (PERSONA AND PROJECT) THAT ENTER AND EXIT THE JOB SITE.

		EXPIRATION DATE OF THE LICENSE 4/30/2024 THIS WORK WAS PREPARED BY ME OR UNDER MY SUPERVISION	E-signed 2024-02-14 09:55AM HST carty.s.chang@hawaii.gov State of Hawaii		drawing no.
			Carty Chang	SCALE: AS SHO	
Ĺ		Kow C. Kar	DRAWN: KJM/AKK	DATE: FEB 2024	
			DESIGNED: GMG	SUBMITTED:	2 - 2 <del>2 - 22</del> - 13
S,		TAWAII, U.S.P			
D		No. 9148-C	CONSTRUCTIO		
		$\left( \star \left( \begin{array}{c} PROFESSIONAL \\ ENGINEER \end{array} \right) \star \right)$	LOW WATER		
			LIHUE-KOLOA F QUEENSLAN		
<u> HIA</u>		C. KAWAAAA	ENGINEERI	ING DIVISION	
-	ſ	AKINAKA & ASSOCIATES, LTD.	STATE C DEPARTMENT OF LAND A	DF HAWAII	RESOURCES
	h	REVISION NO. SYM.	DESCRIPTION	SHT./OF D	ATE APPROVED
EIS	Γ				
,		THE ABOVE ITEMS 1-	ED H.E.T.F. BIOSECURITY N -5)	VIEASUKES (A	AS NUIED IN
VITIY 808)					
NES NTS,		ii. DO NOT TRANSPORT			
		SUSPECTED INFECTED	TREE AND PLACES ON TIME OF THE INFECTION		
RN		808-729-0714 REGA	ARDING THE LOCATION OF G DIGITAL PICTURES OF 1	THE INFECT	ed ohia
		i. Contacting mapua	NA O'SULLIVAN 808–346	-2338 OR S	HERI MANN
BLIC		a. MEASURES INCLUDE /	AND ARE NOT LIMITED TO	:	
021.		DOFAW TAKE MEASURES	S TO PREVENT THE SPRE/ ES.	ad of the (	CERAIOCYSTIS
INT	6.	SITE, THE CONTRACTOR	ECTED OHIA TREES ARE SHALL BE INFORMED AN	d at the di	RECTION OF
D,	Б		EQUIPMENT PRIOR TO MO		O LIOR SITE
OR			D AND PROPERLY DISPOS		
s S		e. IF CONTAMINATED SU	PPLIES ARE DISCOVERED,	THEY MUST	BE
R 15 S		d. IF ITEMS CANNOT BE FOREST.	CLEANED, THEY CANNOT	BROUGHT IN	NIO THE
		TRIP.			
ΙT			HABLE ITEMS SHALL BE F	PERFORMED /	AFTER EACH
) WED		b. CLEANING SHALL BE NEARBY RECEPTACLE	PERFORMED AWAY FROM FOR DISPOSAL.	INE FUKESI	WIIT A
)ODY BE		RINSE AND/OR INSEC			
IMED N			SH, TWEEZERS, CLEAN RA	AG, KNIFE EE	)GE, BLEACH
) IS	4.		LEANING SPECIFIED IN H.E ETHODS OF CLEANING INC		JUKITY
	л	IS AN ATTRACTANT FOR	,		
OR )S		MAY CONTAIN UNSEEN	AND FAUNA AT THE FIELD INSECTS, FUNGUS, BACTE	<b>`</b>	
UST	ى.	DISCARDED FOOD, FROM	CK AND REMOVE ALL TRA 1 THE JOB SITE TO PREVE	ent negativ	ELY
	z				
NG :T			L AND STERILE AND FREE YTHING SUSPICIOUS SHOU		
		AND SUPPLIES.			
		CONSTRUCTION EQUIP	RUCKS, ALL TYPES OF EA PMENT AND GENERAL CON		EQUIPMENT
OR OR		TREADS), AND THE U			
l be		SEATS, FLOORS, DAS	LACES SUCH AS THE INS HBOARDS, DOOR JAMBS,		
M OF		THE TRUCK BEDS SW	IDE OF THE VEHICLES SHU EPT OUT REGULARLY, ESI	PECIALLY IF	USED
-			HELICOPTER SLING NETS,		
		(ROACHES & ANTS),	OPEN FOOD AND WATER	CONTAINERS	, TENTS,
OF		(FOLDS, POCKETS, VE	ELCRO), WOOD AND BUILD S OF PLASTIC BUCKETS, (	ING MATERIA	LS, FENCING
		,	IES-TOOLS, TOOL BAGS,	BACKPACKS	& RAGS
C			POCKETS, JACKETS, RAIN		
			S & FOOTWEAR (TREADS,		
S, THE		PESTS) AND PREVENT S	HARMFUL ORGANISMS (E.( SPREAD TO PRISTINE AND AND CLEAN INCLUDE BU	HEALTHY F	OREST AREAS.
ΉE		AND BEFORE LEAVING A	ANY WEED INFECTED/CON	TAMINATED A	AREA TO
C		VEHICLES SHALL BE INS	SPECTED, CLEANED AND S OX SOLUTION BEFORE EN	SANITIZED WI	TH 70%
0	∠.	PLANT, ANIMAL, OR EAF	R EQUIPMENT AND VEHICL	EQUIPMENT,	GEAR, AND

A ENCLIDE THAT ALL AFAD FALIDMENT AND VEHICLES ADE FORE AF ANY

SHEET NO. 3 OF 18 SHEETS

DATE

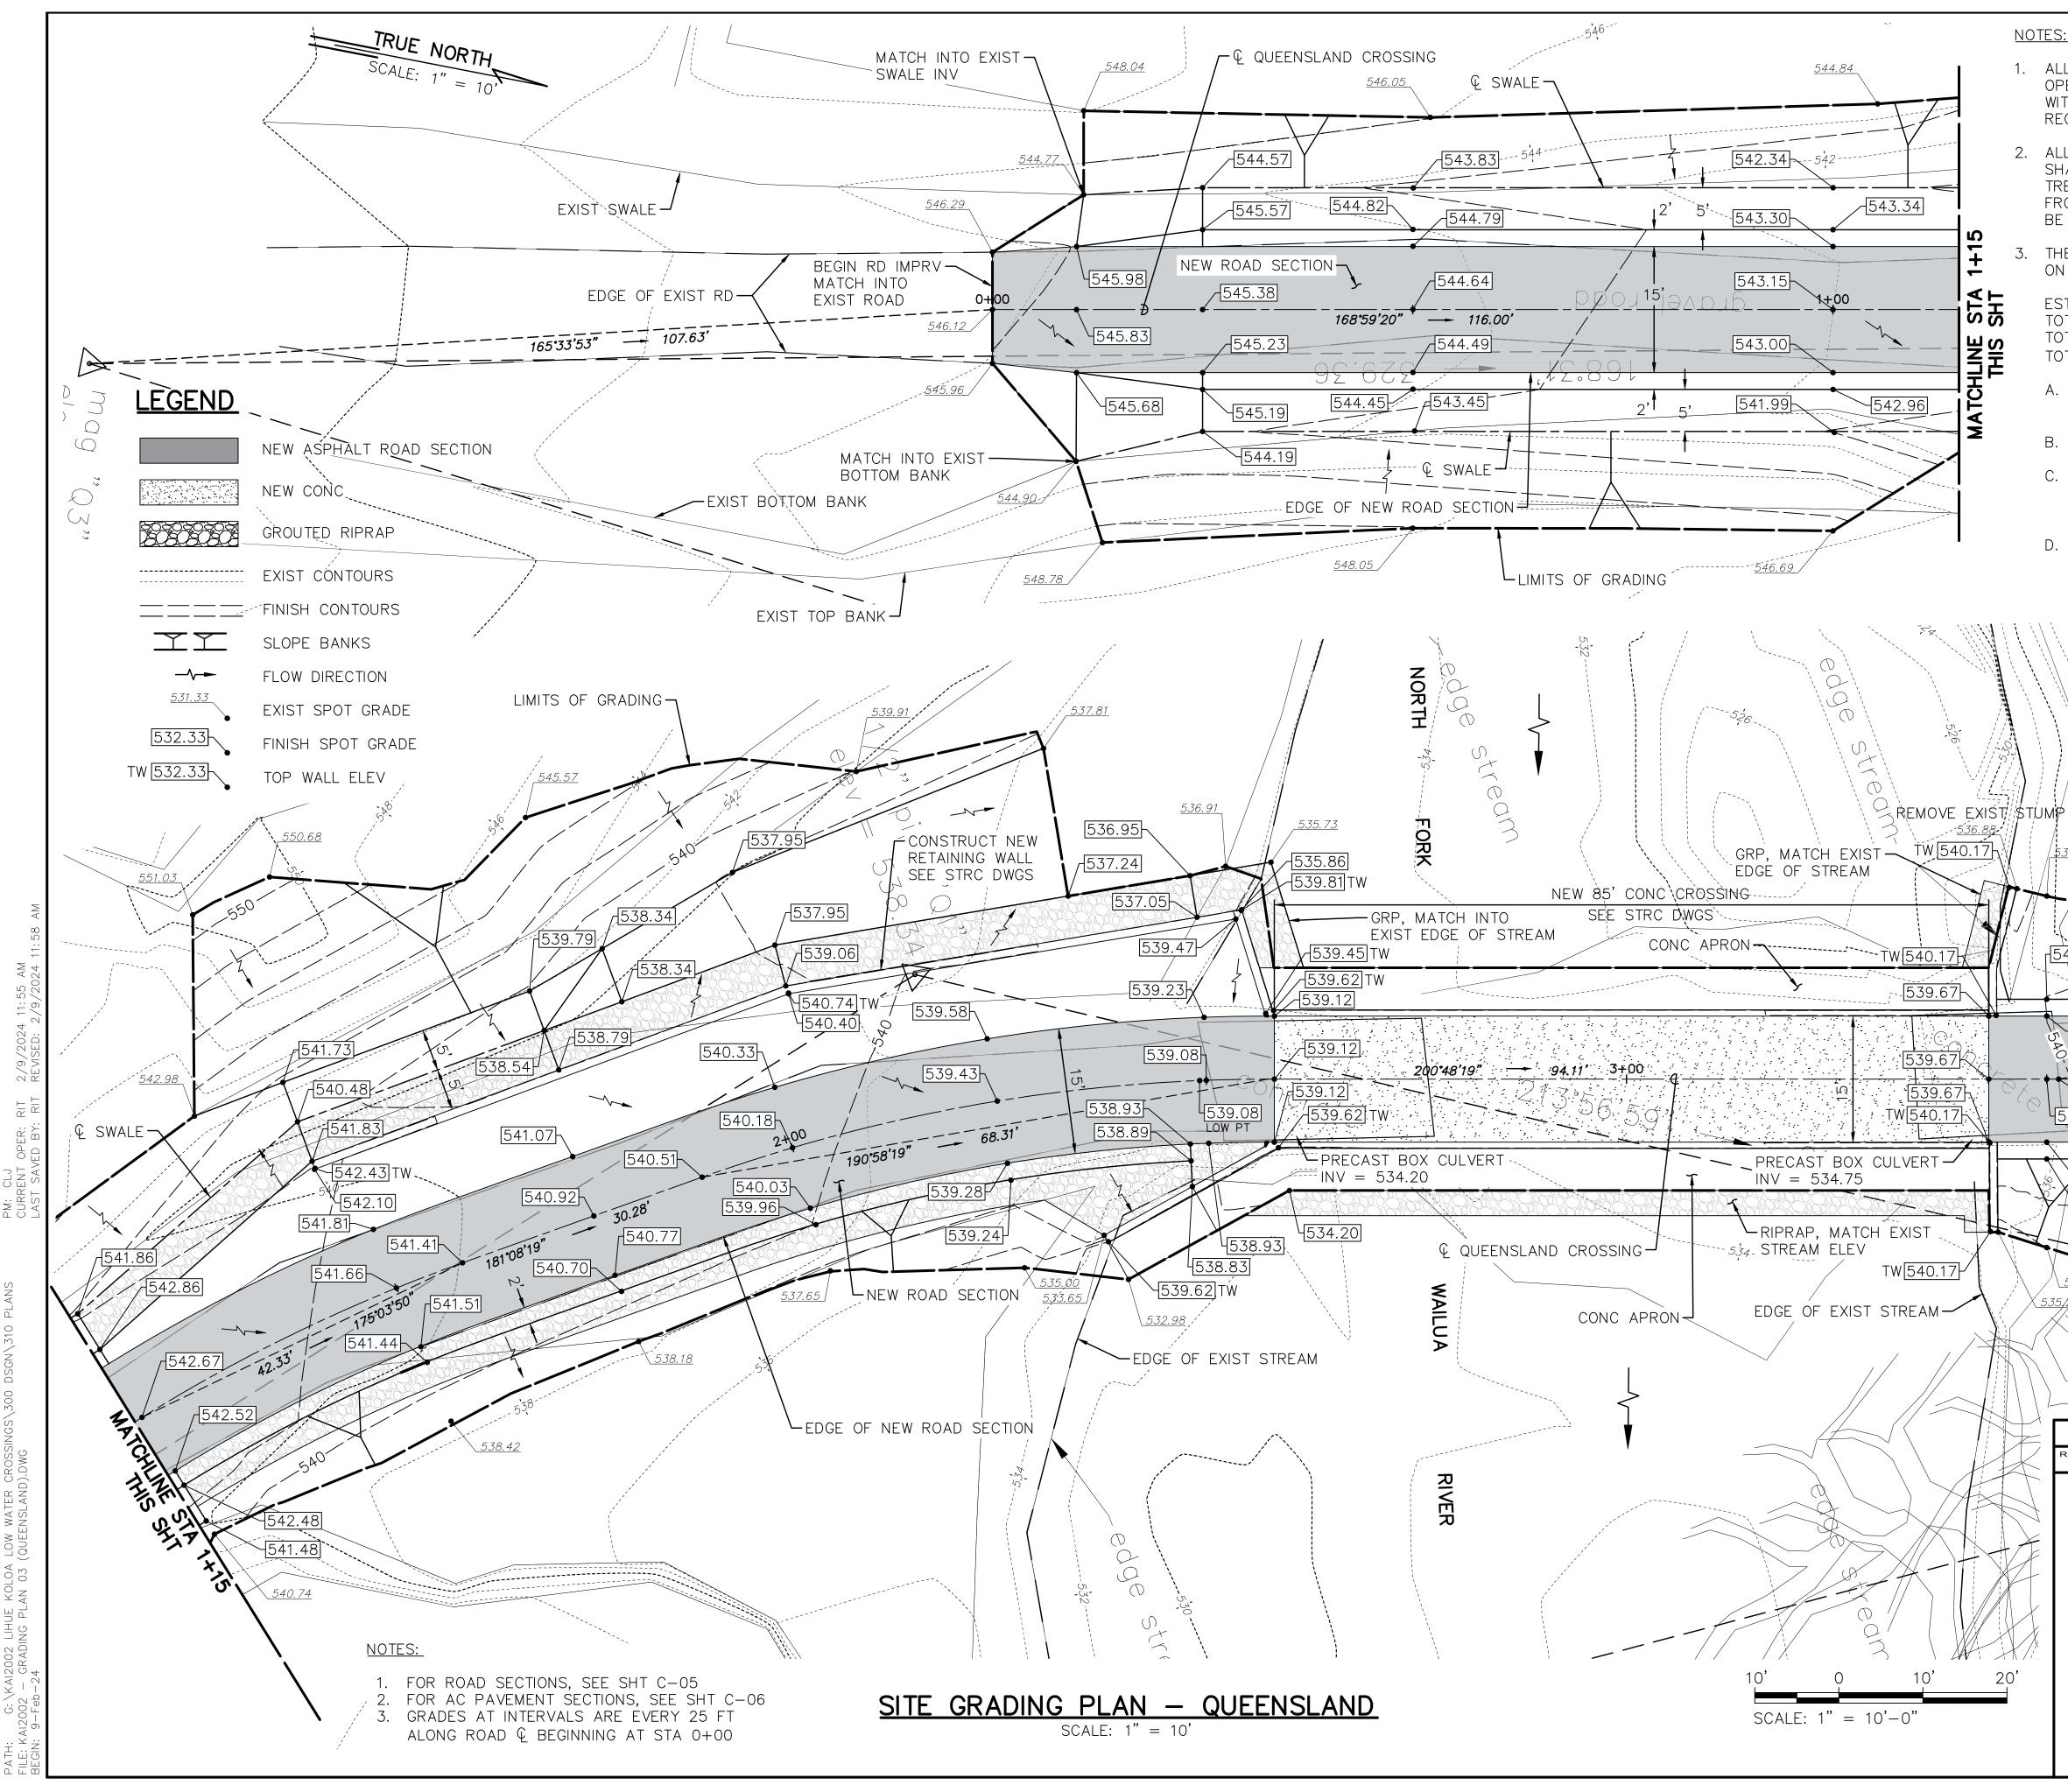


#### NOTES:

- 1. ALL WORK DAMAGED OR CAUSED TO BE DEFECTIVE BY THE CONSTRUCTION OPERATIONS AND WHICH IS NOT INDICATED TO BE REPLACED OR INCLUDED WITH NEW CONSTRUCTION SHALL BE COMPLETELY REPAIRED OR FILLED IN AS REQUIRED TO MATCH THE ADJACENT EXISTING SURFACE.
- 2. ALL TREES SHALL REMAIN UNLESS OTHERWISE NOTED. THE CONTRACTOR SHALL RETAIN THE SERVICES OF A ARBORIST FOR ALL WORK NEAR EXISTING TREES. THE CONTRACTOR SHALL PRESERVE AND PROTECT EXISTING TREES FROM DAMAGE TO FOLIAGE, BRANCHES, TRUNKS OR ROOTS. ARBORIST SHALL BE CERTIFIED BY INTERNATIONAL SOCIETY OF ARBORICULTURE.
- THE CONTRACTOR SHALL REMOVE VEGETATION BEFORE THE PLACING OF FILLS ON A NATURAL GROUND SURFACE.

ESTIMATED EARTHWORK QUANTITIES TOTAL RAW CUT = 145.0 CY TOTAL RAW FILL = 480.0 CY TOTAL AREA TO BE GRADED/DISTURBED = 0.38 AC

- A. THE CONTRACTOR SHALL BE RESPONSIBLE TO DETERMINE THE EXACT QUANTITIES FOR BIDDING PURPOSES.
- B. NO ADJUSTMENT FACTOR IS APPLIED TO THE RAW CUT/FILL QUANTITIES.
- C. EARTHWORK QUANTITIES SHOWN WERE TAKEN FROM EXISTING GROUND TO FINISH GRADE. QUANTITY DOES NOT REFLECT THE EXCAVATION OF PAVEMENT OR CONCRETE FOUNDATION.
- D. CONTRACTOR/PROPOSER SHALL NOT USE THE EARTHWORK QUANTITIES SHOWN ABOVE FOR PROPOSING PURPOSES. REGARDLESS OF THE CUT AND FILL EARTHWORK QUANTITIES SHOWN ABOVE, THE CONTRACTOR IS RESPONSIBLE TO IMPORT OR EXPORT ALL NECESSARY MATERIALS TO COMPLETE THE GRADING WORK AT NO ADDITIONAL COST TO THE STATE.

RUE NORTH. -MATCH INTO EXIST EXIST TOP BANK BOTTOM BANK END RD IMPRV <u>542.07</u> MATCH INTO EXIST ROAD V TO KEAHUA ARBORETUM 542.50 541.51 541.24 542.46 \_\_<u>542.81</u> 540.04 542.31h 4+100 541.20 <sup>~1</sup>\_178•48'19" \ 189°48'19" \_ \_ \_ \_ 38.16' \_ \_ <u>542.69</u> 20.00' 541.80 <u>541.93</u> 541.05 1539.93 542.16 539.86 542.12 √540.90 € 5,39.95 540.86 539.73 03,10" 4539.69 MATCH INTO EXIST-BOTTOM BANK LNEW ROAD SECTION EXIST BOTTOM BANK LIMITS OF GRADING REVISION NO. SYM DESCRIPTION SHT./OF DATE APPROVED STATE OF HAWAII AKINAKA & ASSOCIATES, LTD. DEPARTMENT OF LAND AND NATURAL RESOURCES ENGINEERING DIVISION KAWA LIHUE-KOLOA FOREST RESERVE LICENSED QUEENSLAND LOOP ROAD LOW WATER CROSSING ENGINEER No. 9148-C SITE GRADING PLAN - QUEENSLAND R SUBMITTED: DESIGNED: GMG Ken C. Kal DRAWN: KJM/AKK DATE: FEB 2024 SCALE: AS SHOWN CHECKED: KCK DRAWING NO. APPR Carty Chang EXPIRATION DATE OF THE LICENSE 4/30/2024 E-signed 2024-02-14 09:55AM HST C-03 THIS WORK WAS PREPARED BY carty.s.chang@hawaii.gov ME OR UNDER MY SUPERVISION DATE CHIEF State of Hawaii Chief Engineer SHEET NO. 4 OF 18 SHEETS

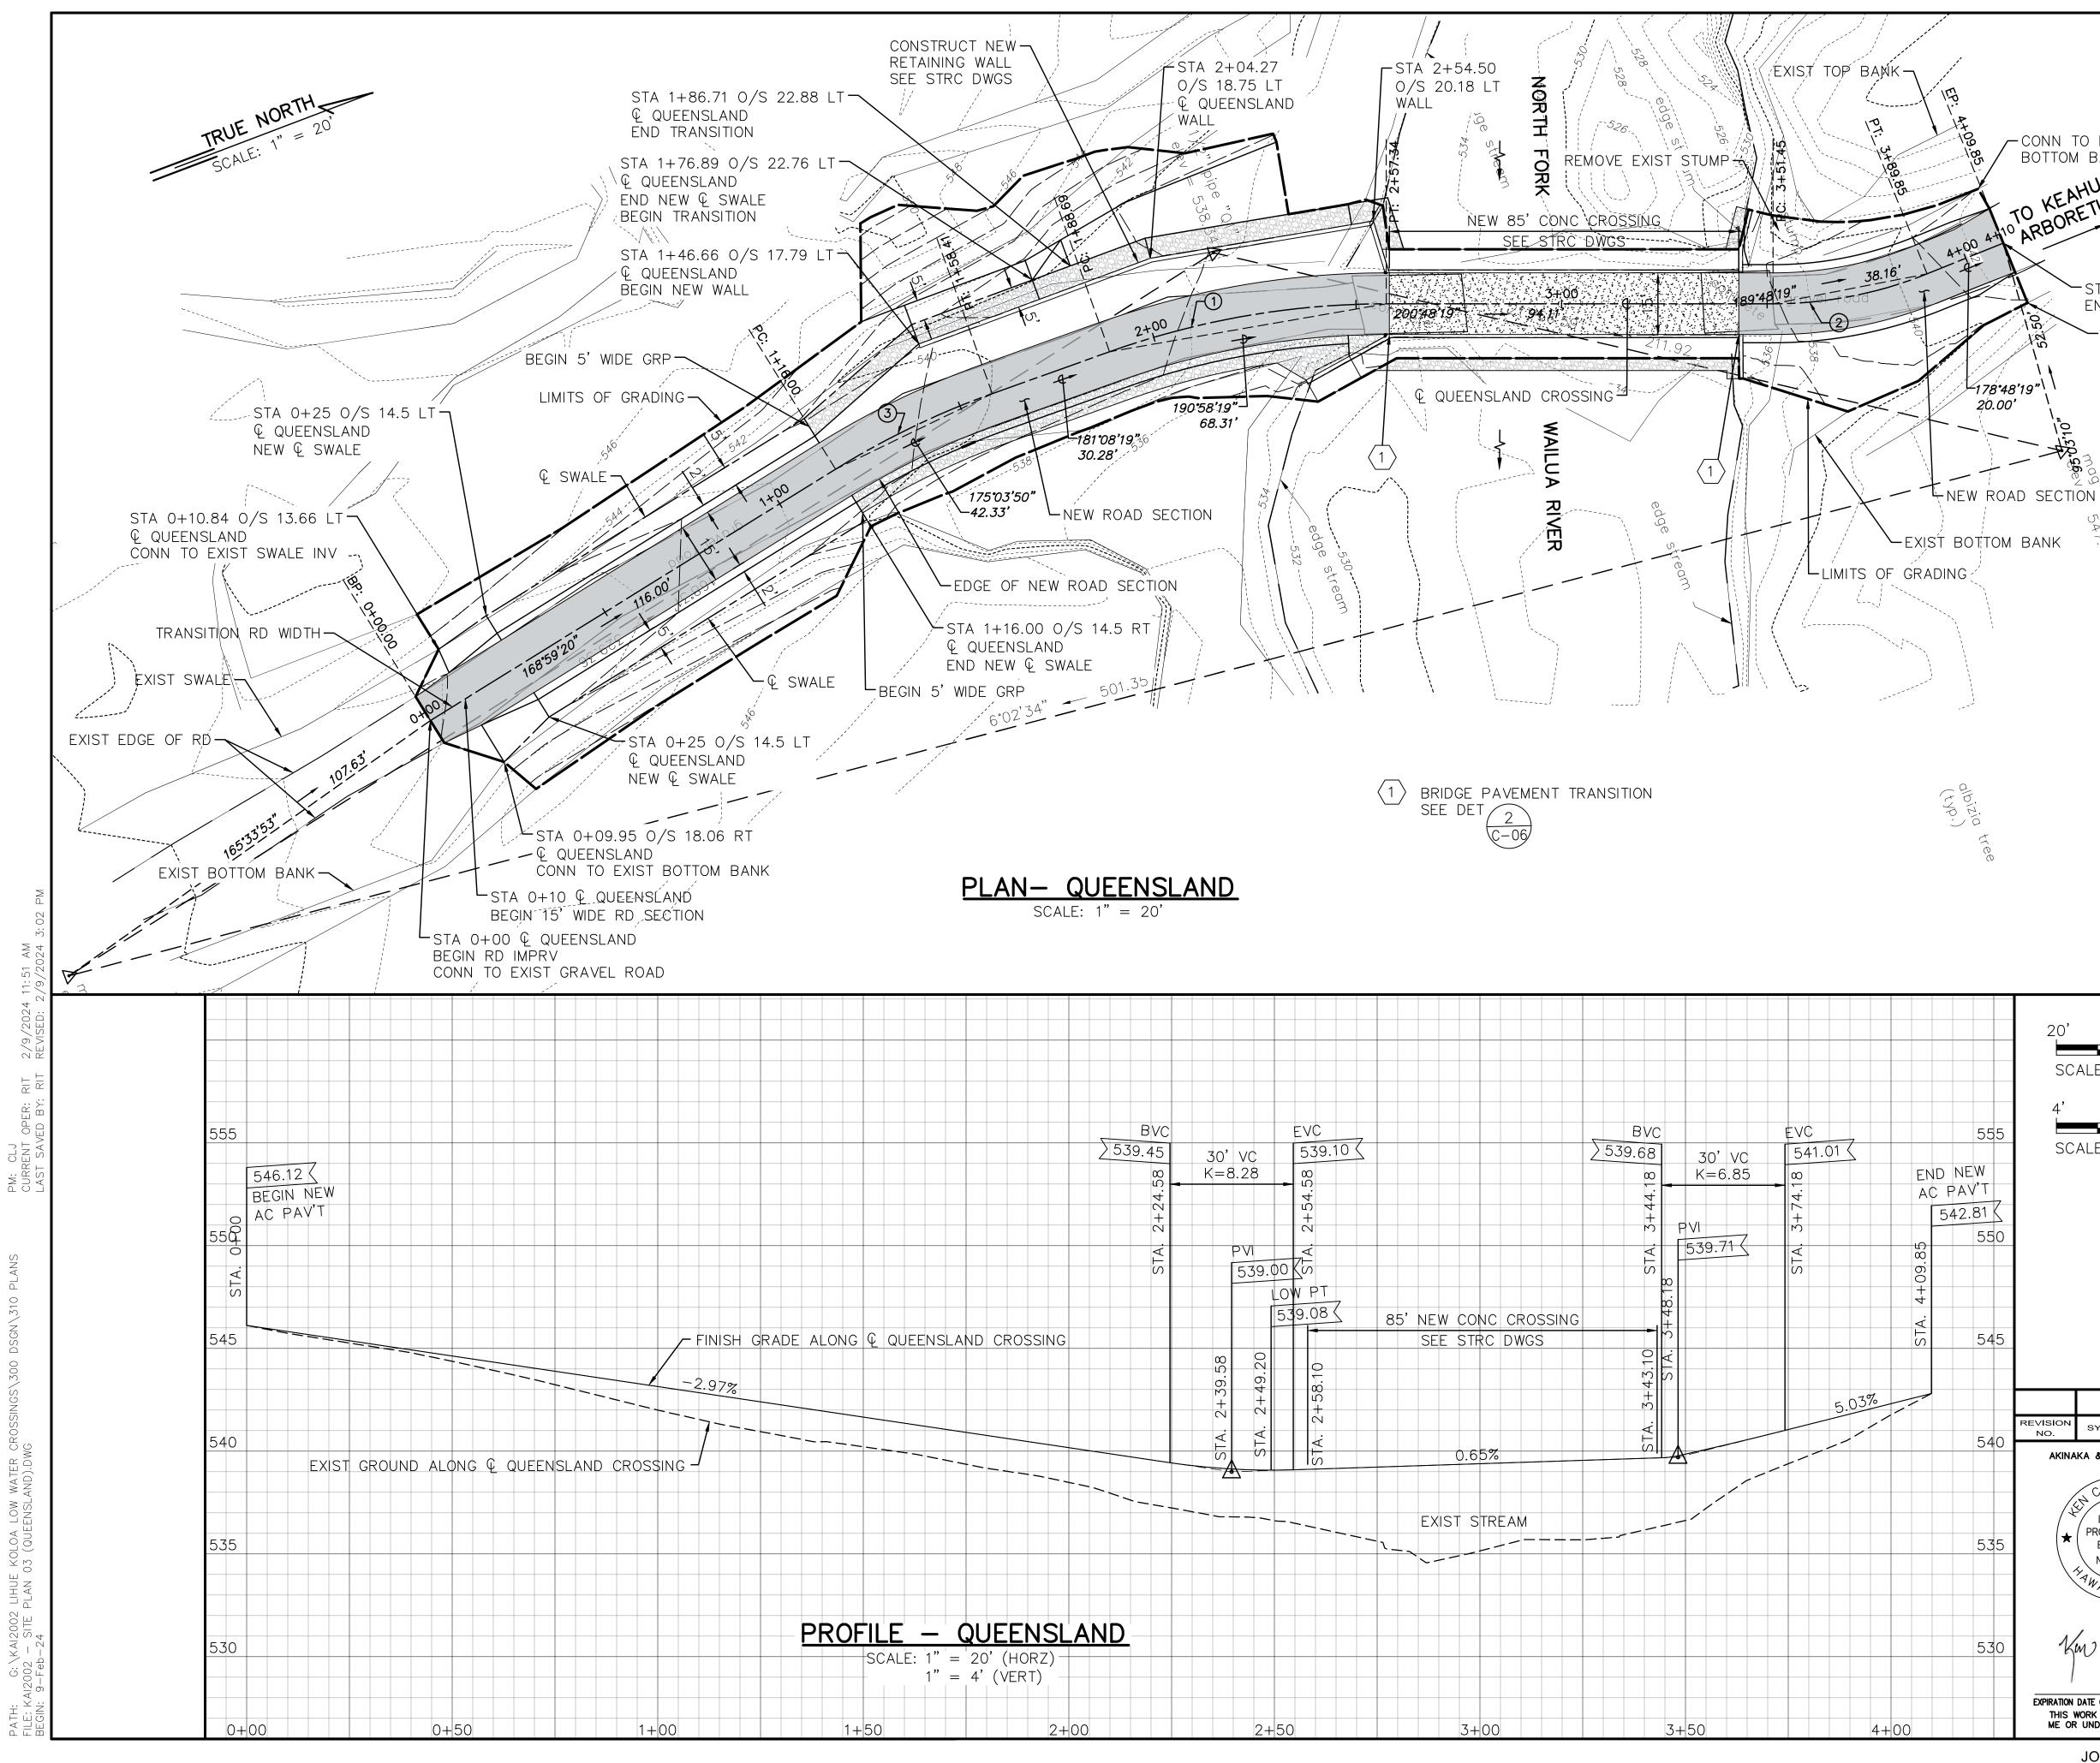

			CURVE	e data			
1	CURVE	Δ	Δ/2	R	Т	С	Lc
	1	19°40'00"	9°50'00"	200.00	34.67	68.31	68.65
18 - CONN TO EXIST	2	22°00'00"	11°00'00"	100.00	19.44	38.16	38.40
BOTTOM BANK	3	12°08'59"	6°04'30"	200.00	21.29	42.33	42.41
TO KEAHUA TO KEAHUA ARBORETUM							

∽STA 4+09.85 € QUEENSLAND END RD IMPRV CONN TO EXIST ROAD  $\sim$  conn to exist bottom bank


XXX

<sup>(1\_</sup>178**°**48'19"\ 20.00'

## <u>LEGEND</u>


	NEW ASPHALT ROAD SECTION
	NEW CONC
	GROUTED RIPRAP
	EXIST. CONTOURS
	FINISH CONTOURS
YY	SLOPE BANKS

	20'		0	20'	40'					
	SC	ALE:	1" = 20' - 0	)"						
	4'		0	4'	8'					
555										
	SC	ALE:	1" = 4' - 0"	,						
) NEW										
PAV'T										
542.81 (										
550										
545										
								1		_
540	REVISION NO.	SYM.		D	ESCRIPTION			SHT./OF	DATE	APPROVED
540	NO.		SSOCIATES, LTD.				_	HAWAII		
540	NO. AKINA	KA & AS				ENT OF LA		HAWAII	RAL RES	
540	NO. AKINA	KA & AS	(AWALTAD		DEPARTM	ENT OF LA	AND AN NEERIN	HAWAII D NATU G DIVISI	RAL RES	OURCES
		KA & AS	KAWALLA P		DEPARTMI LIHU (	ENT OF LA ENGIN JE-KOLC QUEENS	AND AN NEERIN DA FO LAND	HAWAII D NATU G DIVISI REST LOOP	RAL RES ION RESER ROAD	OURCES
540	NO. AKINA	KA & AS	KAWA+44 INSED SSIONAL INEER ★		DEPARTMI LIHU C	ENT OF LA ENGIN JE-KOLO QUEENS LOW WA	AND AN NEERIN DA FO LAND	HAWAII D NATU G DIVISI REST LOOP CROSS	RAL RES ION RESER ROAD SING	OURCES
		KA & AS	KAWALLY NSED SSIONAL INEER 148-C		DEPARTMI LIHU C	ENT OF LA ENGIN JE-KOLC QUEENS LOW WA	AND AN NEERIN DA FO LAND ATER ( ND	HAWAII D NATU G DIVISI REST LOOP CROSS PROF	RAL RES ION RESER ROAD SING	OURCES
		KA & AS	KAWALLY NSED SSIONAL INEER 148-C		DEPARTMI LIHU C	ENT OF LA ENGIN JE-KOLC QUEENS LOW WA	AND AN NEERIN DA FO LAND ATER ( ND	HAWAII D NATU G DIVISI REST LOOP CROSS	RAL RES ION RESER ROAD SING ILE - D	OURCES
		KA & AS	KAWAAA NSED SSIONAL INEER 148-C U.S. ►		DEPARTMI LIHU C	ENT OF LA ENGIN JE-KOLC QUEENS LOW WA LAN A QU	AND AN JEERIN DA FO LAND ATER ( ND EENS	HAWAII D NATU G DIVISI REST LOOP CROSS PROF	RAL RES ION RESER ROAD SING ILE - D	OURCES
		KA & AS	KAWAAA NSED SSIONAL INEER 148-C U.S. ►	DES	DEPARTMI LIHU (	ENT OF LA ENGIN JE-KOLC QUEENS LOW WA LAN A QU	AND AN JEERIN DA FO LAND ATER ( ND EENS	HAWAII D NATU G DIVISI REST LOOP CROSS PROF SLANI	RAL RES ION RESER ROAD SING ILE D	OURCES
535		KA & AS	KAWAAA NSED SSIONAL INEER 148-C U.S. ►	DES		ENT OF LA ENGIN JE-KOLC QUEENS LOW WA LAN A QU	AND AN NEERIN DA FO LAND ATER ( ND EENS	HAWAII D NATU G DIVISI REST LOOP CROSS PROF SLANI	RAL RES ON RESER ROAD SING ILE D D: 3 2024	OURCES
535	NO. AKINA	KA & AS	XAWAXYON SSIONAL INEER 148-C U.S. V.S. Xan	DES DRA CHF Cart	DEPARTMI LIHU C IGNED: GMG WN: KJM/AKI	ENT OF LA ENGIN JE-KOLC QUEENS LOW WA LAN A QU	AND AN JEERIN DA FO LAND ATER ( ND EENS	HAWAII D NATU G DIVISI REST LOOP CROSS PROF SLANI	RAL RES ION RESER ROAD SING ILE D D 2024 S SHOWN	OURCES
535		KA & AS	KAWAAAAAAAAAAAAAAAAAAAAAAAAAAAAAAAAAAA	DES DRA CHF E-sig carty	DEPARTMI LIHU C IGNED: GMG WN: KJM/AKI CKED: KCK y Chang gned 2024-02-1 y.s.chang@hav	ENT OF LA ENGIN JE-KOLO QUEENS LOW WA LAN A QU	AND AN JEERIN DA FO LAND ATER ( ND EENS	HAWAII D NATU G DIVISI REST LOOP CROSS PROF SLANI	RAL RES ON RESER ROAD SING ILE - D 2024 S SHOWN	OURCES
535		KA & AS	KAWAAA NSED SSIONAL INEER 148-C U.S. V.S. Xav HE LICENSE 4/30/2024	DES DRA CHF Cart State Chie	DEPARTMI LIHU C IGNED: GMG WN: KJM/AKI CKED: KCK y Chang gned 2024-02-1	ENT OF LA ENGIN JE-KOLC QUEENS LOW WA LAN A QU	AND AN JEERIN DA FO LAND ATER ( ND EENS	HAWAII D NATU G DIVISI REST LOOP CROSS PROF SLANI	RAL RES ON RESER ROAD SING ILE - D 2024 S SHOWN	OURCES VE

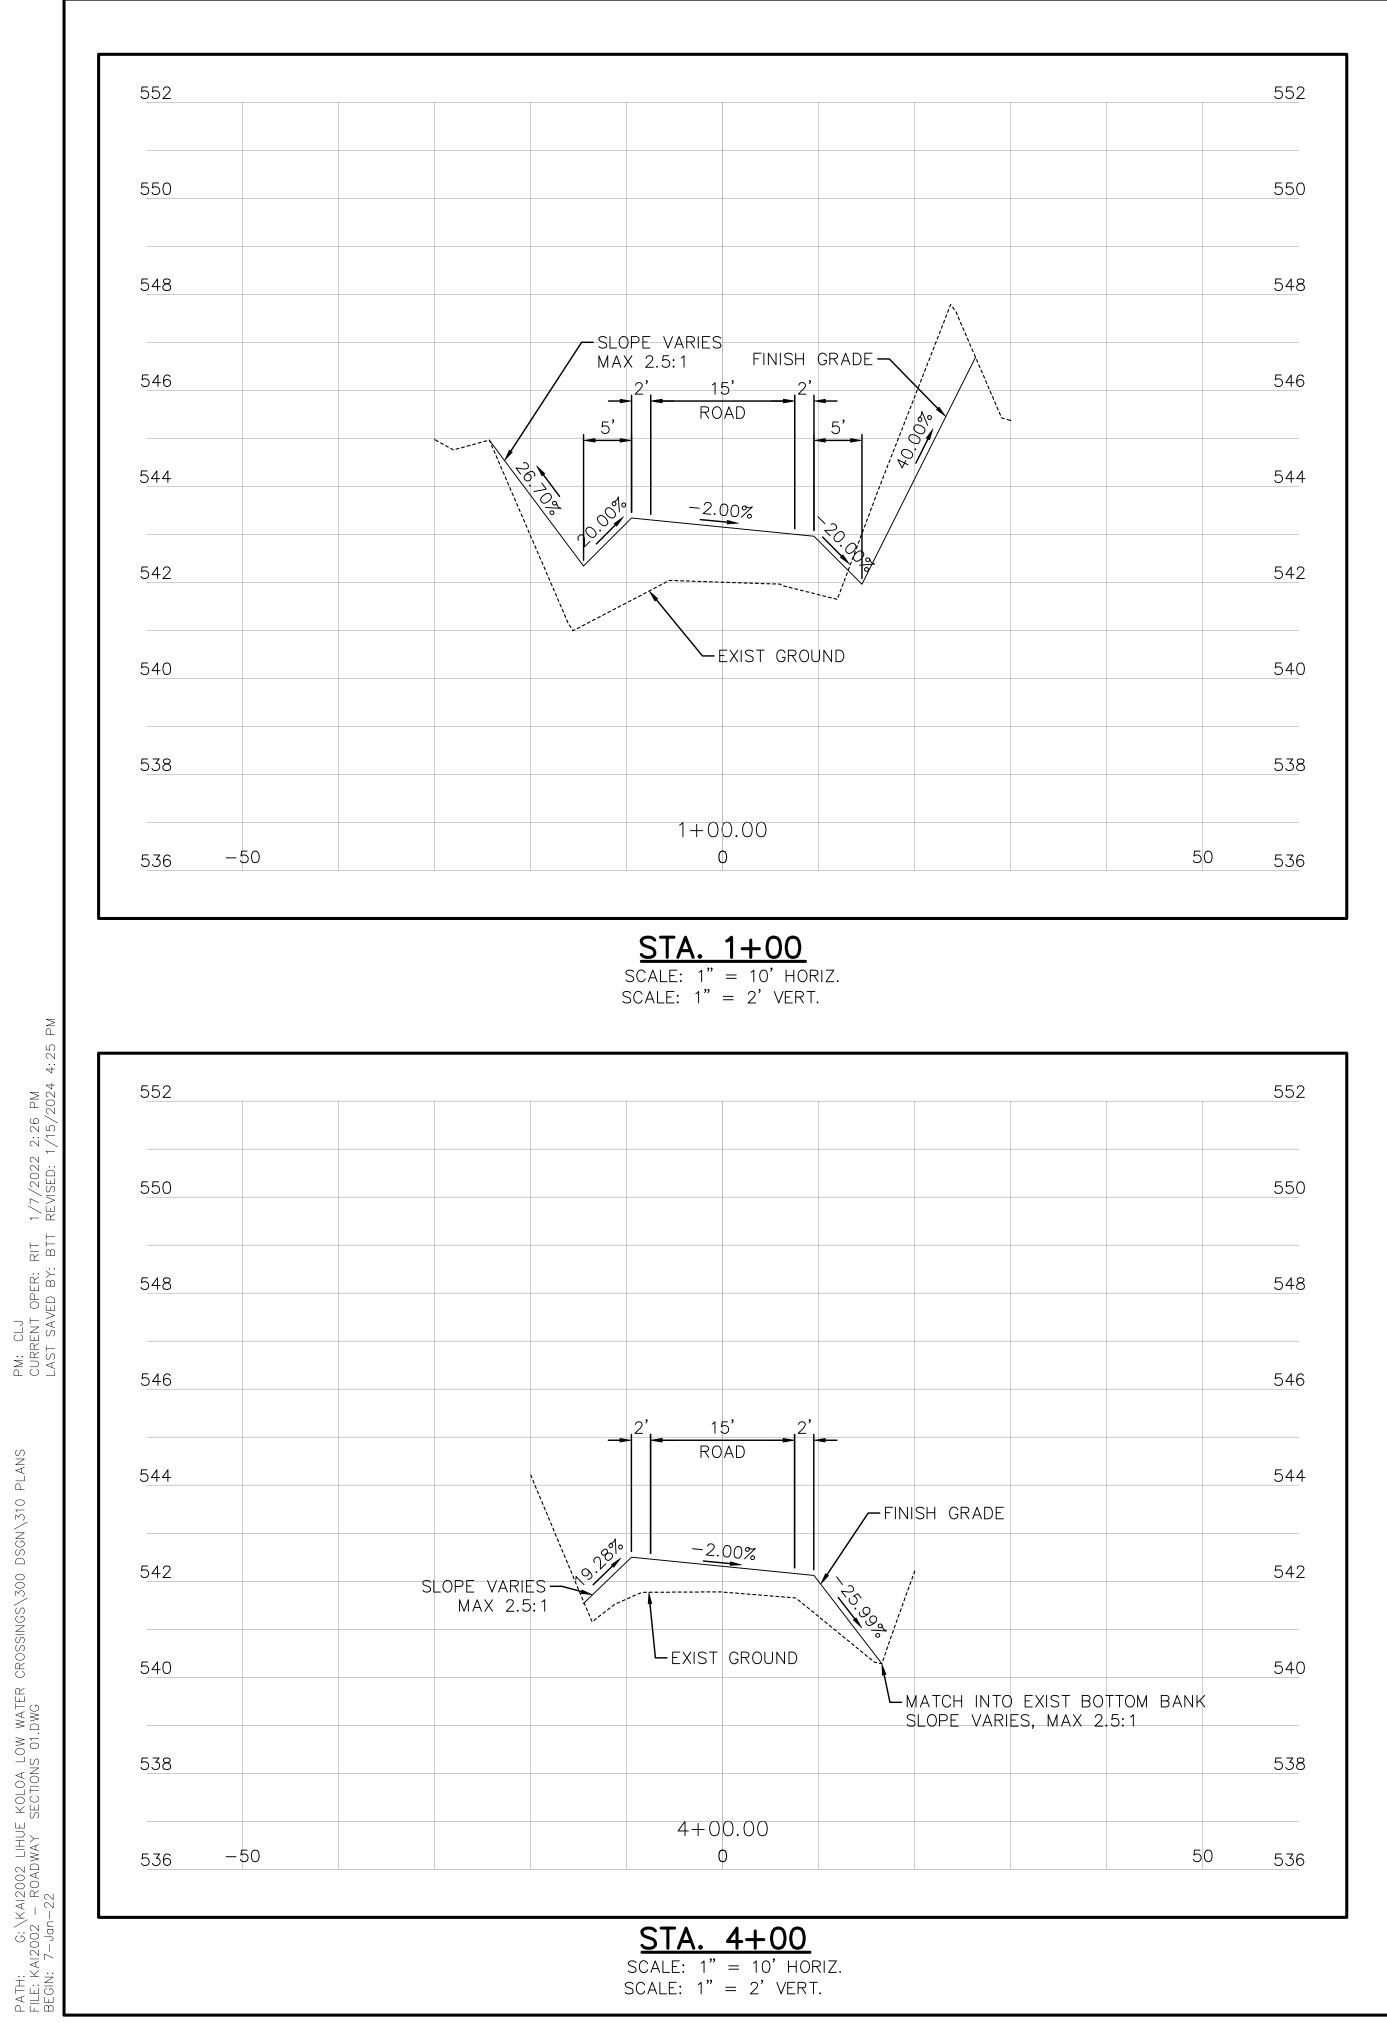

MAG 2 2:26 1/7/2 REVISE

G:\KAI2002 LIHUE KOLOA LOW WATER AI2002 - ROADWAY SECTIONS 01.DWG 7-.Inn-22

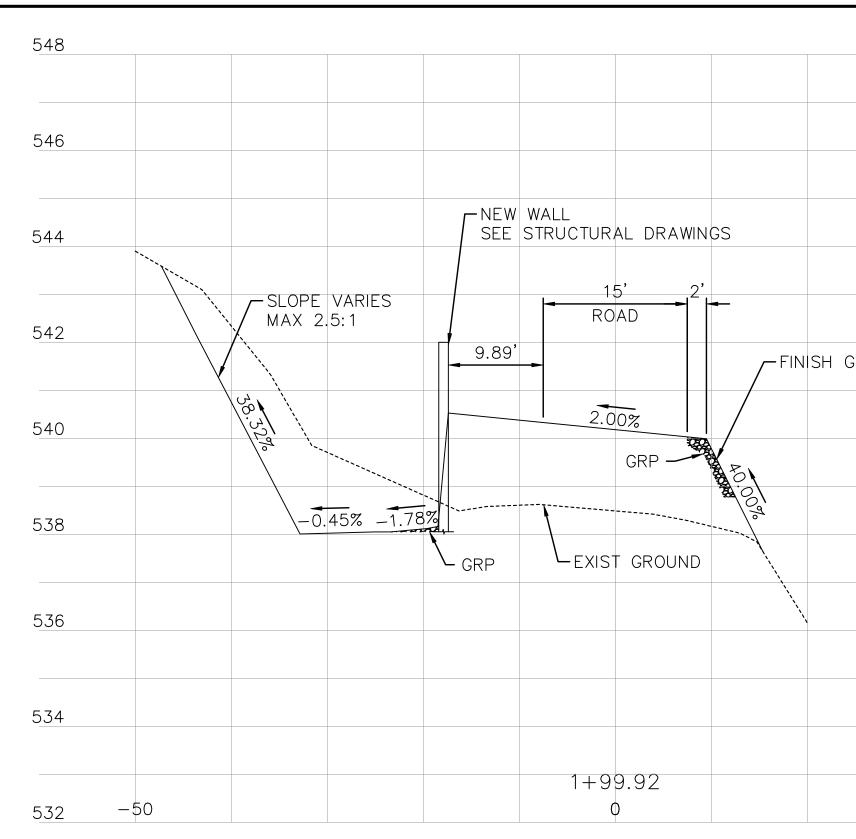


<u>STA. 1+99.92</u> SCALE: 1" = 10' HORIZ. SCALE: 1" = 2' VERT.

NOTES: FOR AC PAVEMENT SECTIONS, SEE SHT C-06

10' 20' 10' SCALE: 1'' = 10' - 0''SCALE: 1'' = 2' - 0''

	 	1	548
			546
			544
			542
GRADE			
			540
			538
			536
			534
	5	0	532


REVISION NO.	SYM.		DESCRIPTION	SHT./OF	DATE	APPROVED	
AKINAKA & ASSOCIATES, LTD.			STATE OF HAWAII DEPARTMENT OF LAND AND NATURAL RESOURCES ENGINEERING DIVISION				
			QUEENSLAND	LIHUE-KOLOA FOREST RESERVE QUEENSLAND LOOP ROAD LOW WATER CROSSING			
	No. 9	148-C	ROADWAY SECTIONS 01 - QUEENSLAND				
					60 k	4	
	/ .	. / .	DESIGNED: GMG	SUBMITTE	D:	73-8890	
K	ín C	Karl	DRAWN: KJM/AKK	DATE: FEE	3 2024		
	Ken C. Kar		CHECKED: KCK	SCALE: AS	SHOWN		
THIS V	NORK WAS	HE LICENSE 4/30/2024 S PREPARED BY MY SUPERVISION	APPR Carty Chang E-signed 2024-02-14 09:55AM HST carty.s.chang@hawaii.gov State of Hawaii	DATE	(	awing no. <b>C-05</b>	
JOB NO. D00AK67B Chief Engineer SHEET NO. 6 OF 18 SHEETS						ETS	

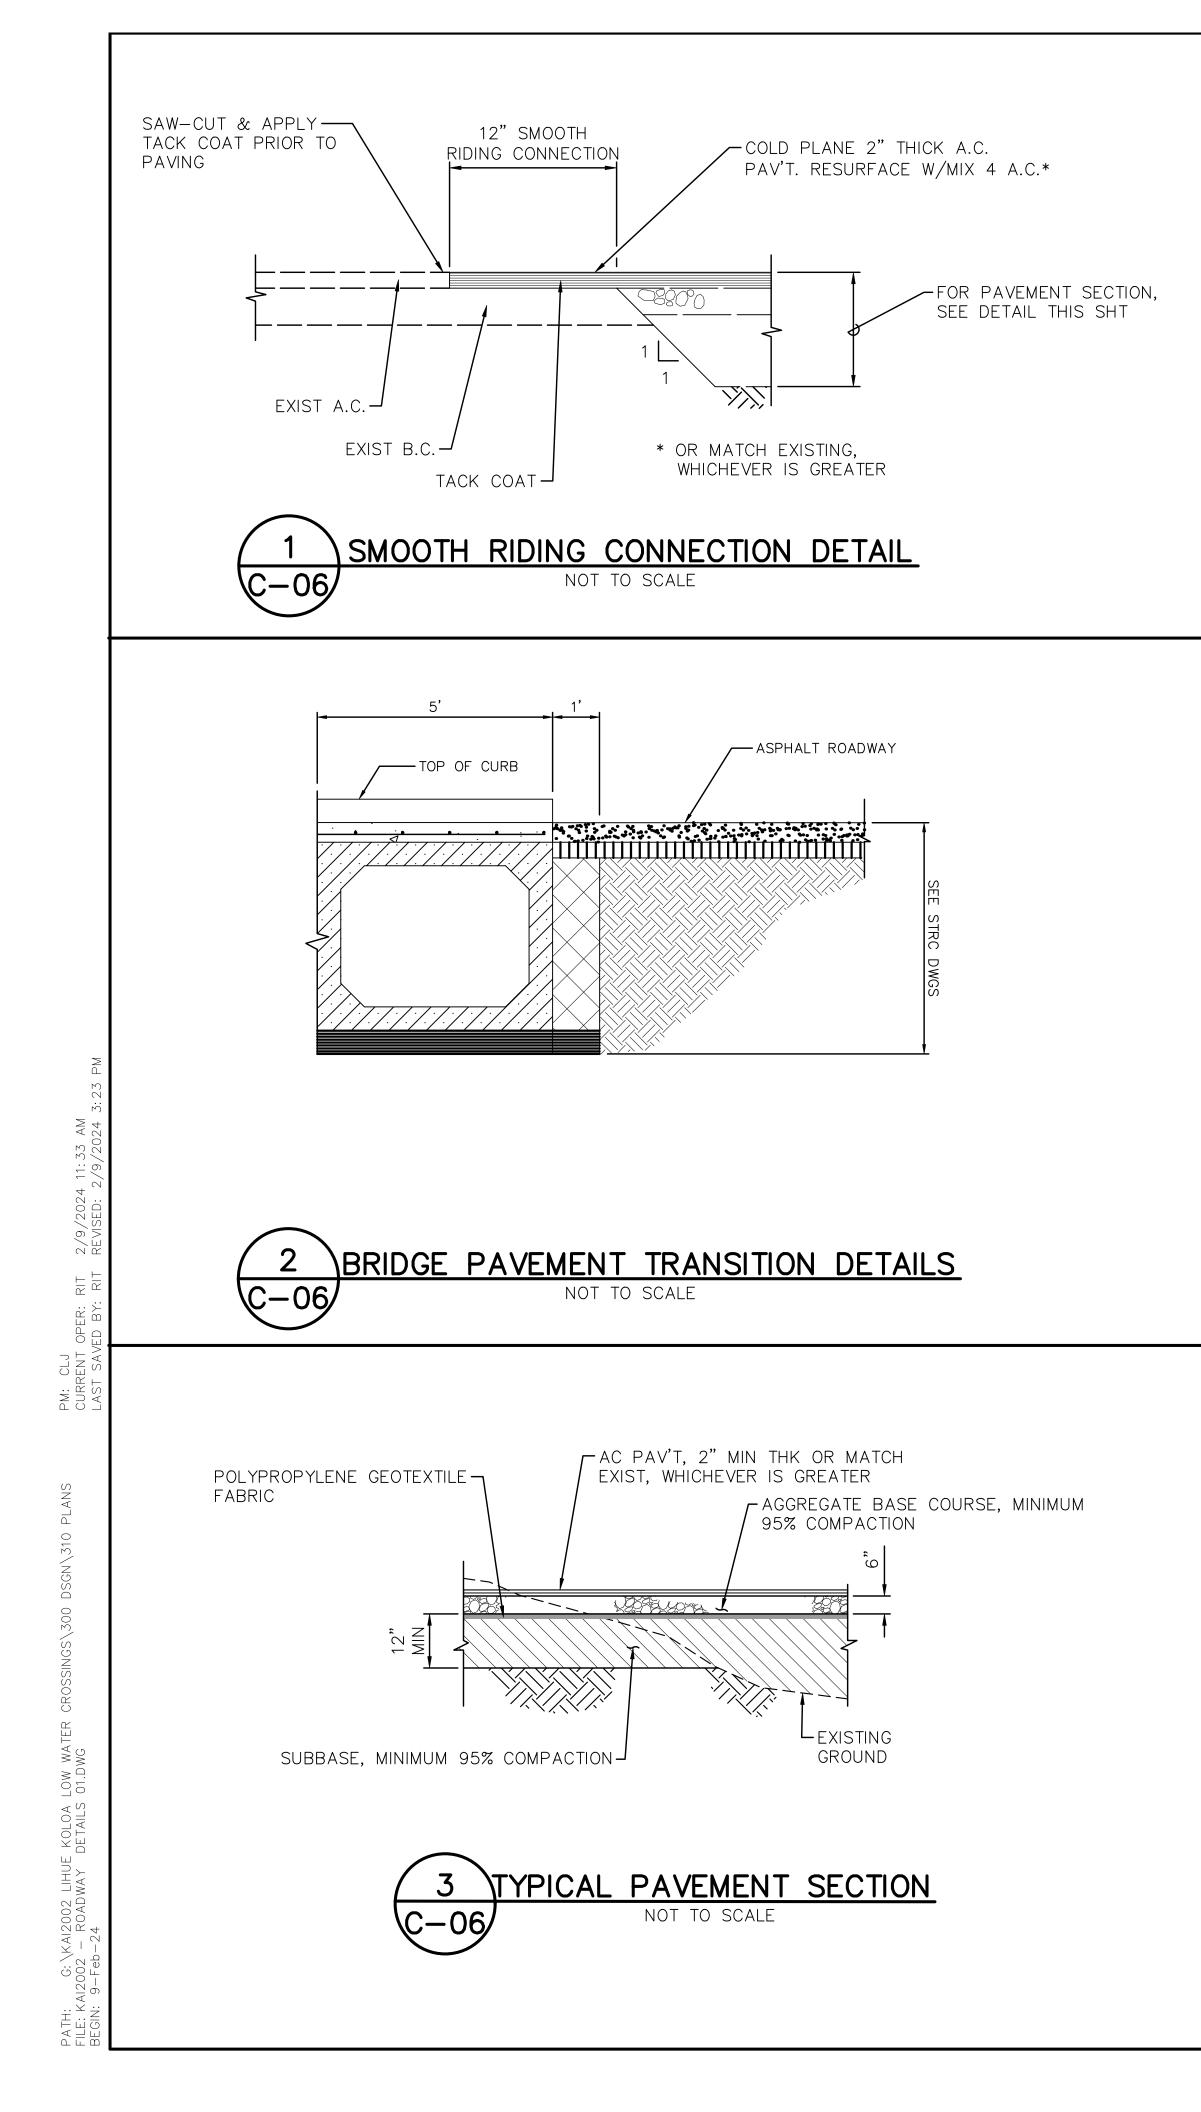

<u>BMP NOTES:</u>

- 1. CONSTRUCTION WORK WITHIN THE STREAM BED SHALL BE DONE DURING DRY PERIODS WHEN STREAM FLOW IS MINIMAL. WORK SHALL BE DISCONTINUED DURING STORM EVENTS OR DURING FLOOD CONDITION.
- 2. FILL MATERIAL FOR SAND BAGS SHALL BE CLEANED GRANULAR MATERIAL. CONTRACTOR TO SUBMIT SPECIFICATIONS OF THE SAND BAG AND FILL MATERIAL PRIOR TO CONSTRUCTION. FILL MATERIAL SHALL BE CLEANED OFFSITE. RUNOFF FROM CLEANING OF FILL MATERIAL SHALL NOT BE DISCHARGED INTO STATE WATERS.
- 3. TREATED WOOD MATERIAL IS NOT PERMITTED FOR FORMS WITHIN THE STREAM CHANNEL.
- BMPS ARE REQUIRED FOR CONTRACTOR'S STOCKPILE AND STAGING AREAS TO PREVENT CONTAMINATED RUNOFF FROM FLOWING INTO STATE WATERS.
- 5. RUNOFF COLLECTED WITHIN CONTAINED AREAS SHALL NOT BE ALLOWED TO FLOW INTO STREAM CHANNEL OR ANY STATE WATERS.
- 6. FRESH CONCRETE SHALL BE PREVENTED FROM ENTERING THE STREAM DURING ALL CONCRETING WORK. CONCRETE SHALL NOT OVERFLOW FORMWORK. FORMWORK AND JOINTS SHALL BE SEALED AGAINST CONCRETE LEAKAGE.
- 7. NO DEBRIS SHALL BE ALLOWED TO ENTER THE STREAM. A PAN SHALL BE USED TO CAPTURE DEBRIS DURING SOIL NAIL WALL WORK.
- 8. DISTURBED AREAS SHALL BE RESTORED TO PRE-CONSTRUCTION CONDITION.


					-	-		
REVISION NO.	SYM.		DESCRIPTION	SHT./OF	DATE	APPROVED		
AKINAKA & ASSOCIATES, LTD.			STATE OF HAWAII DEPARTMENT OF LAND AND NATURAL RESOURCES ENGINEERING DIVISION					
			LIHUE-KOLOA FO QUEENSLANE LOW WATER	LOOP	ROAD	Έ		
	No. 9	148-C , U.S. P.	ROADWAY DETAILS 01 – QUEENSLAND					
		,		G		4		
	/	. / .	DESIGNED: GMG	SUBMITTE	D:			
K	m C	Karl	DRAWN: KJM/AKK	DATE: FEB 2024				
	Kow C. Kar		CHECKED: KCK	SCALE: AS	SHOWN			
THIS V	NORK WAS	HE LICENSE 4/30/2024 S PREPARED BY MY SUPERVISION	APPR Carty Chang E-signed 2024-02-14 09:55AM HST carty.s.chang@hawaii.gov State of Hawaii	DATE	(	awing no. C-06		
	JOB I	NO. D00AK67B	Chief Engineer SHEET NO.	7 OF	18 SHE	ETS		

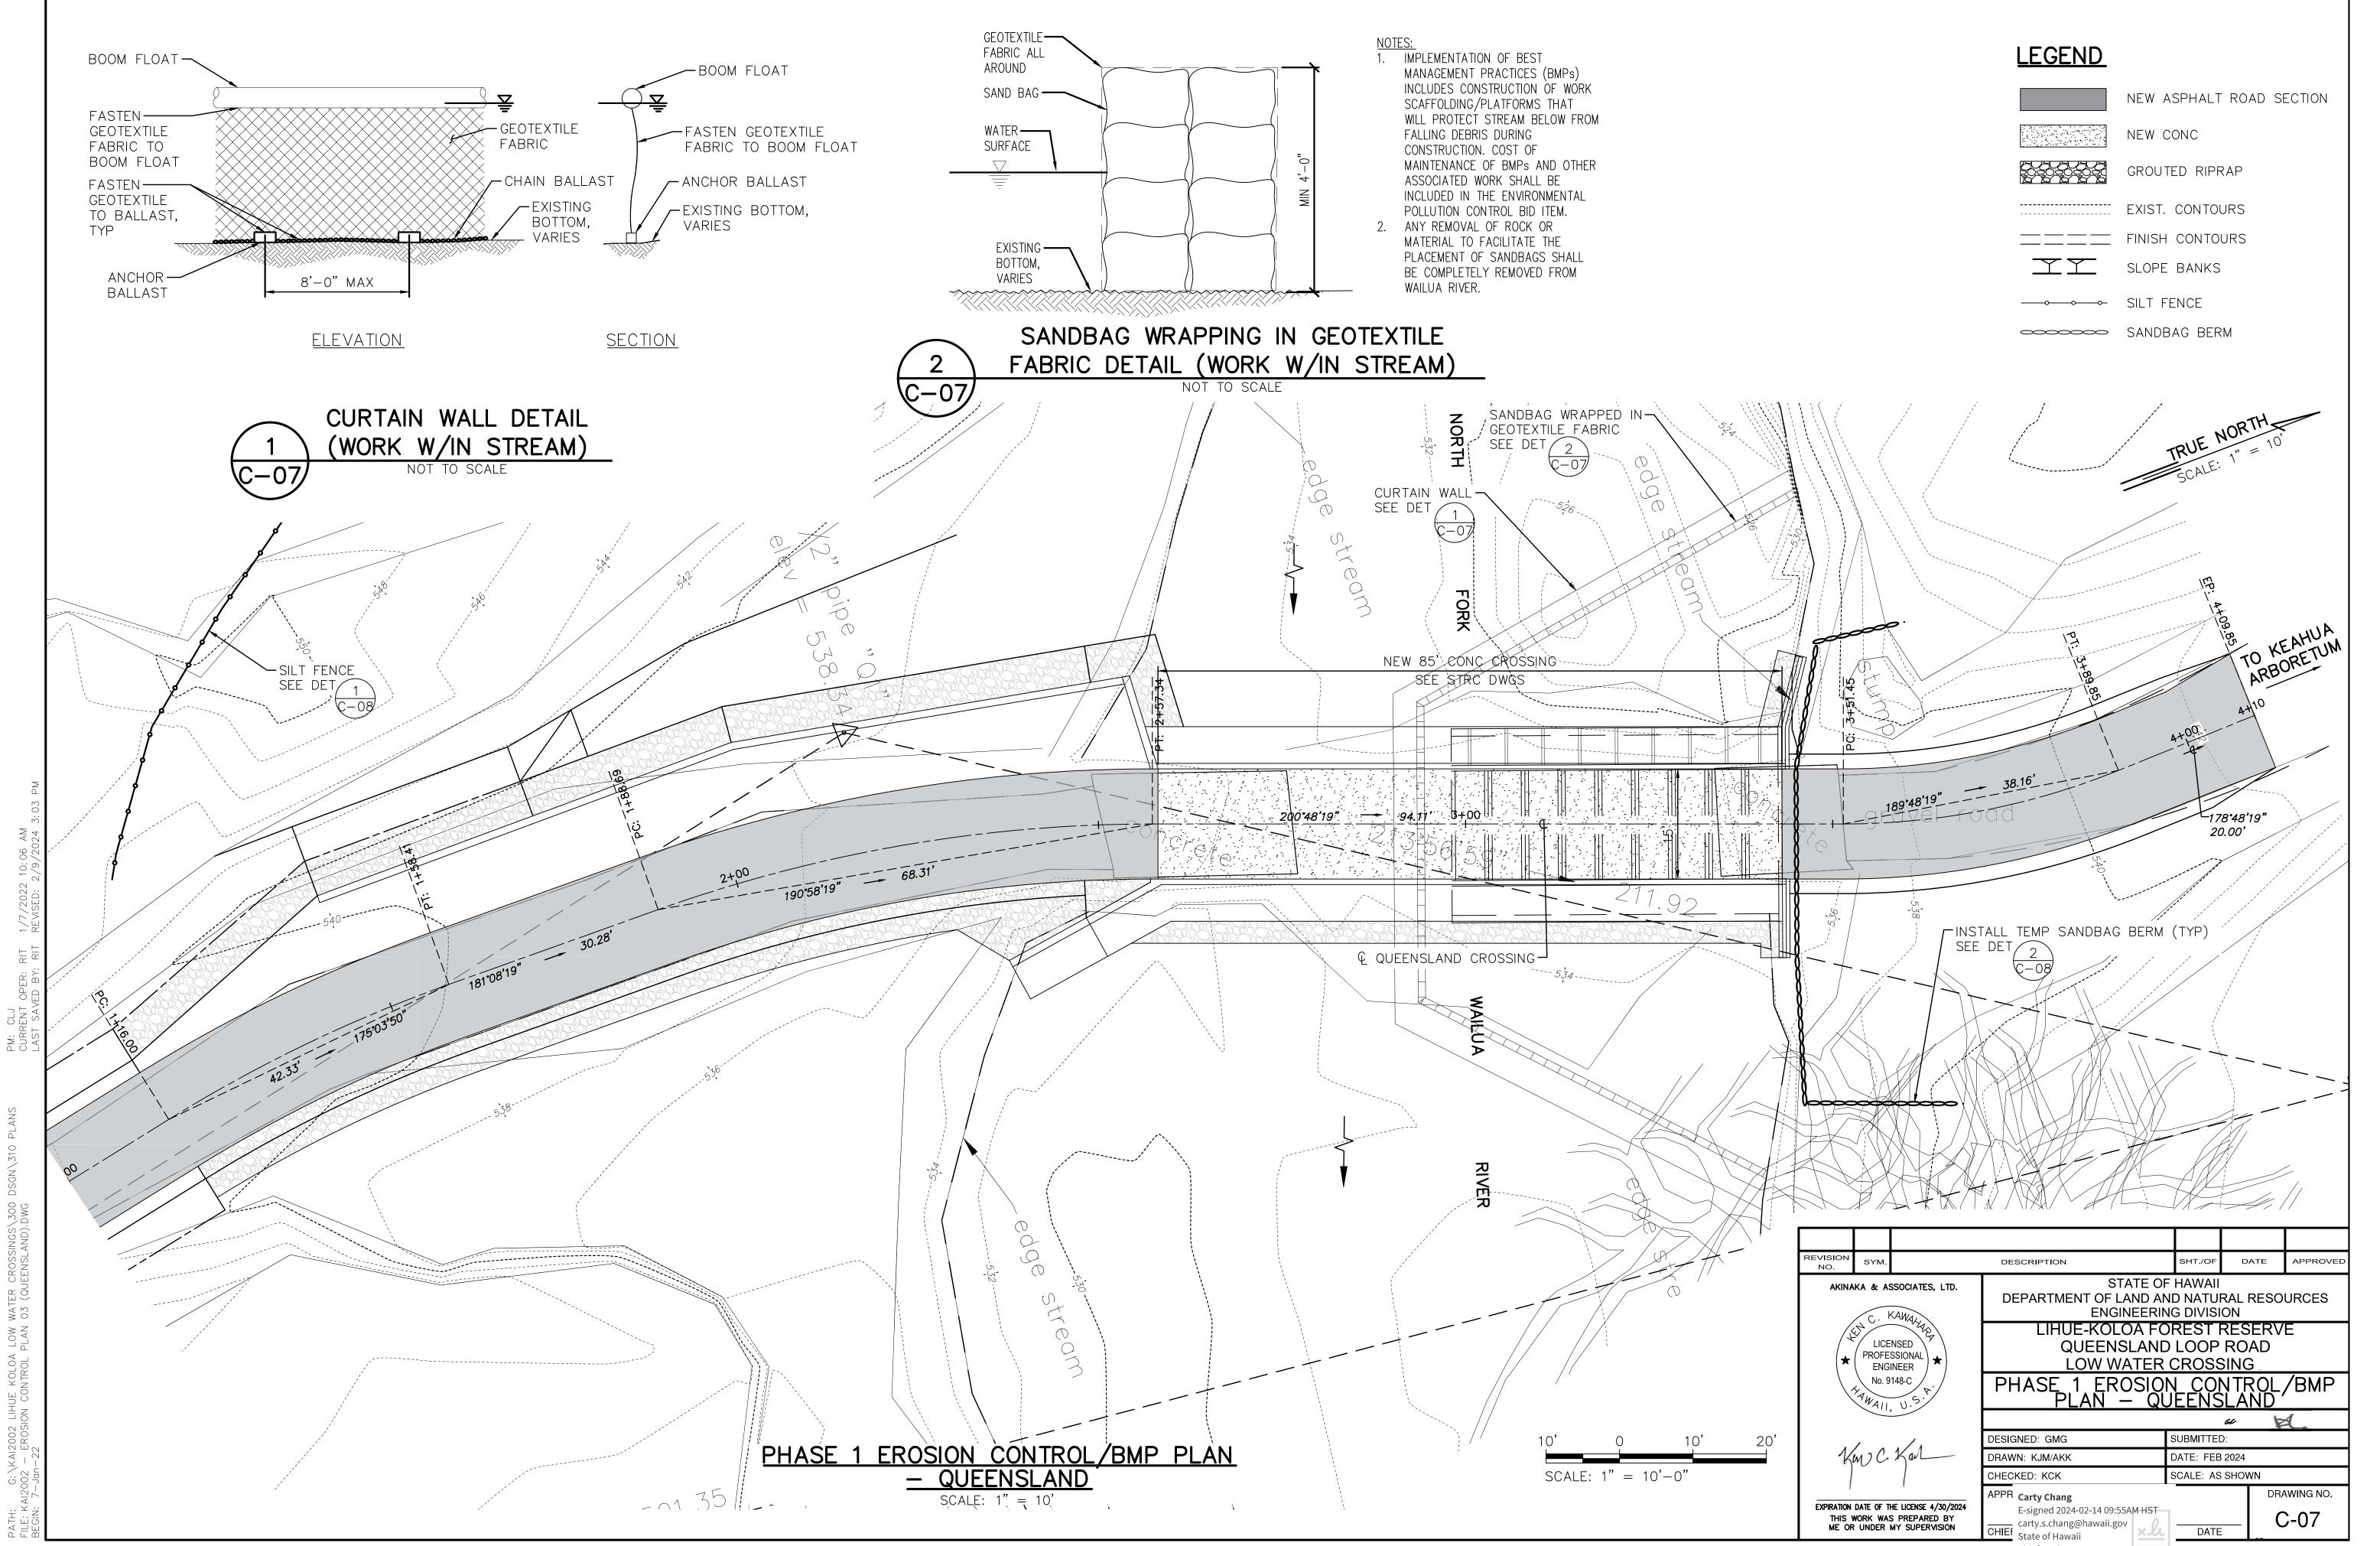

JOB NO. D00AK67B

Chief Engineer SHEET NO. 8 OF 18 SHEETS

<sup>107</sup> D

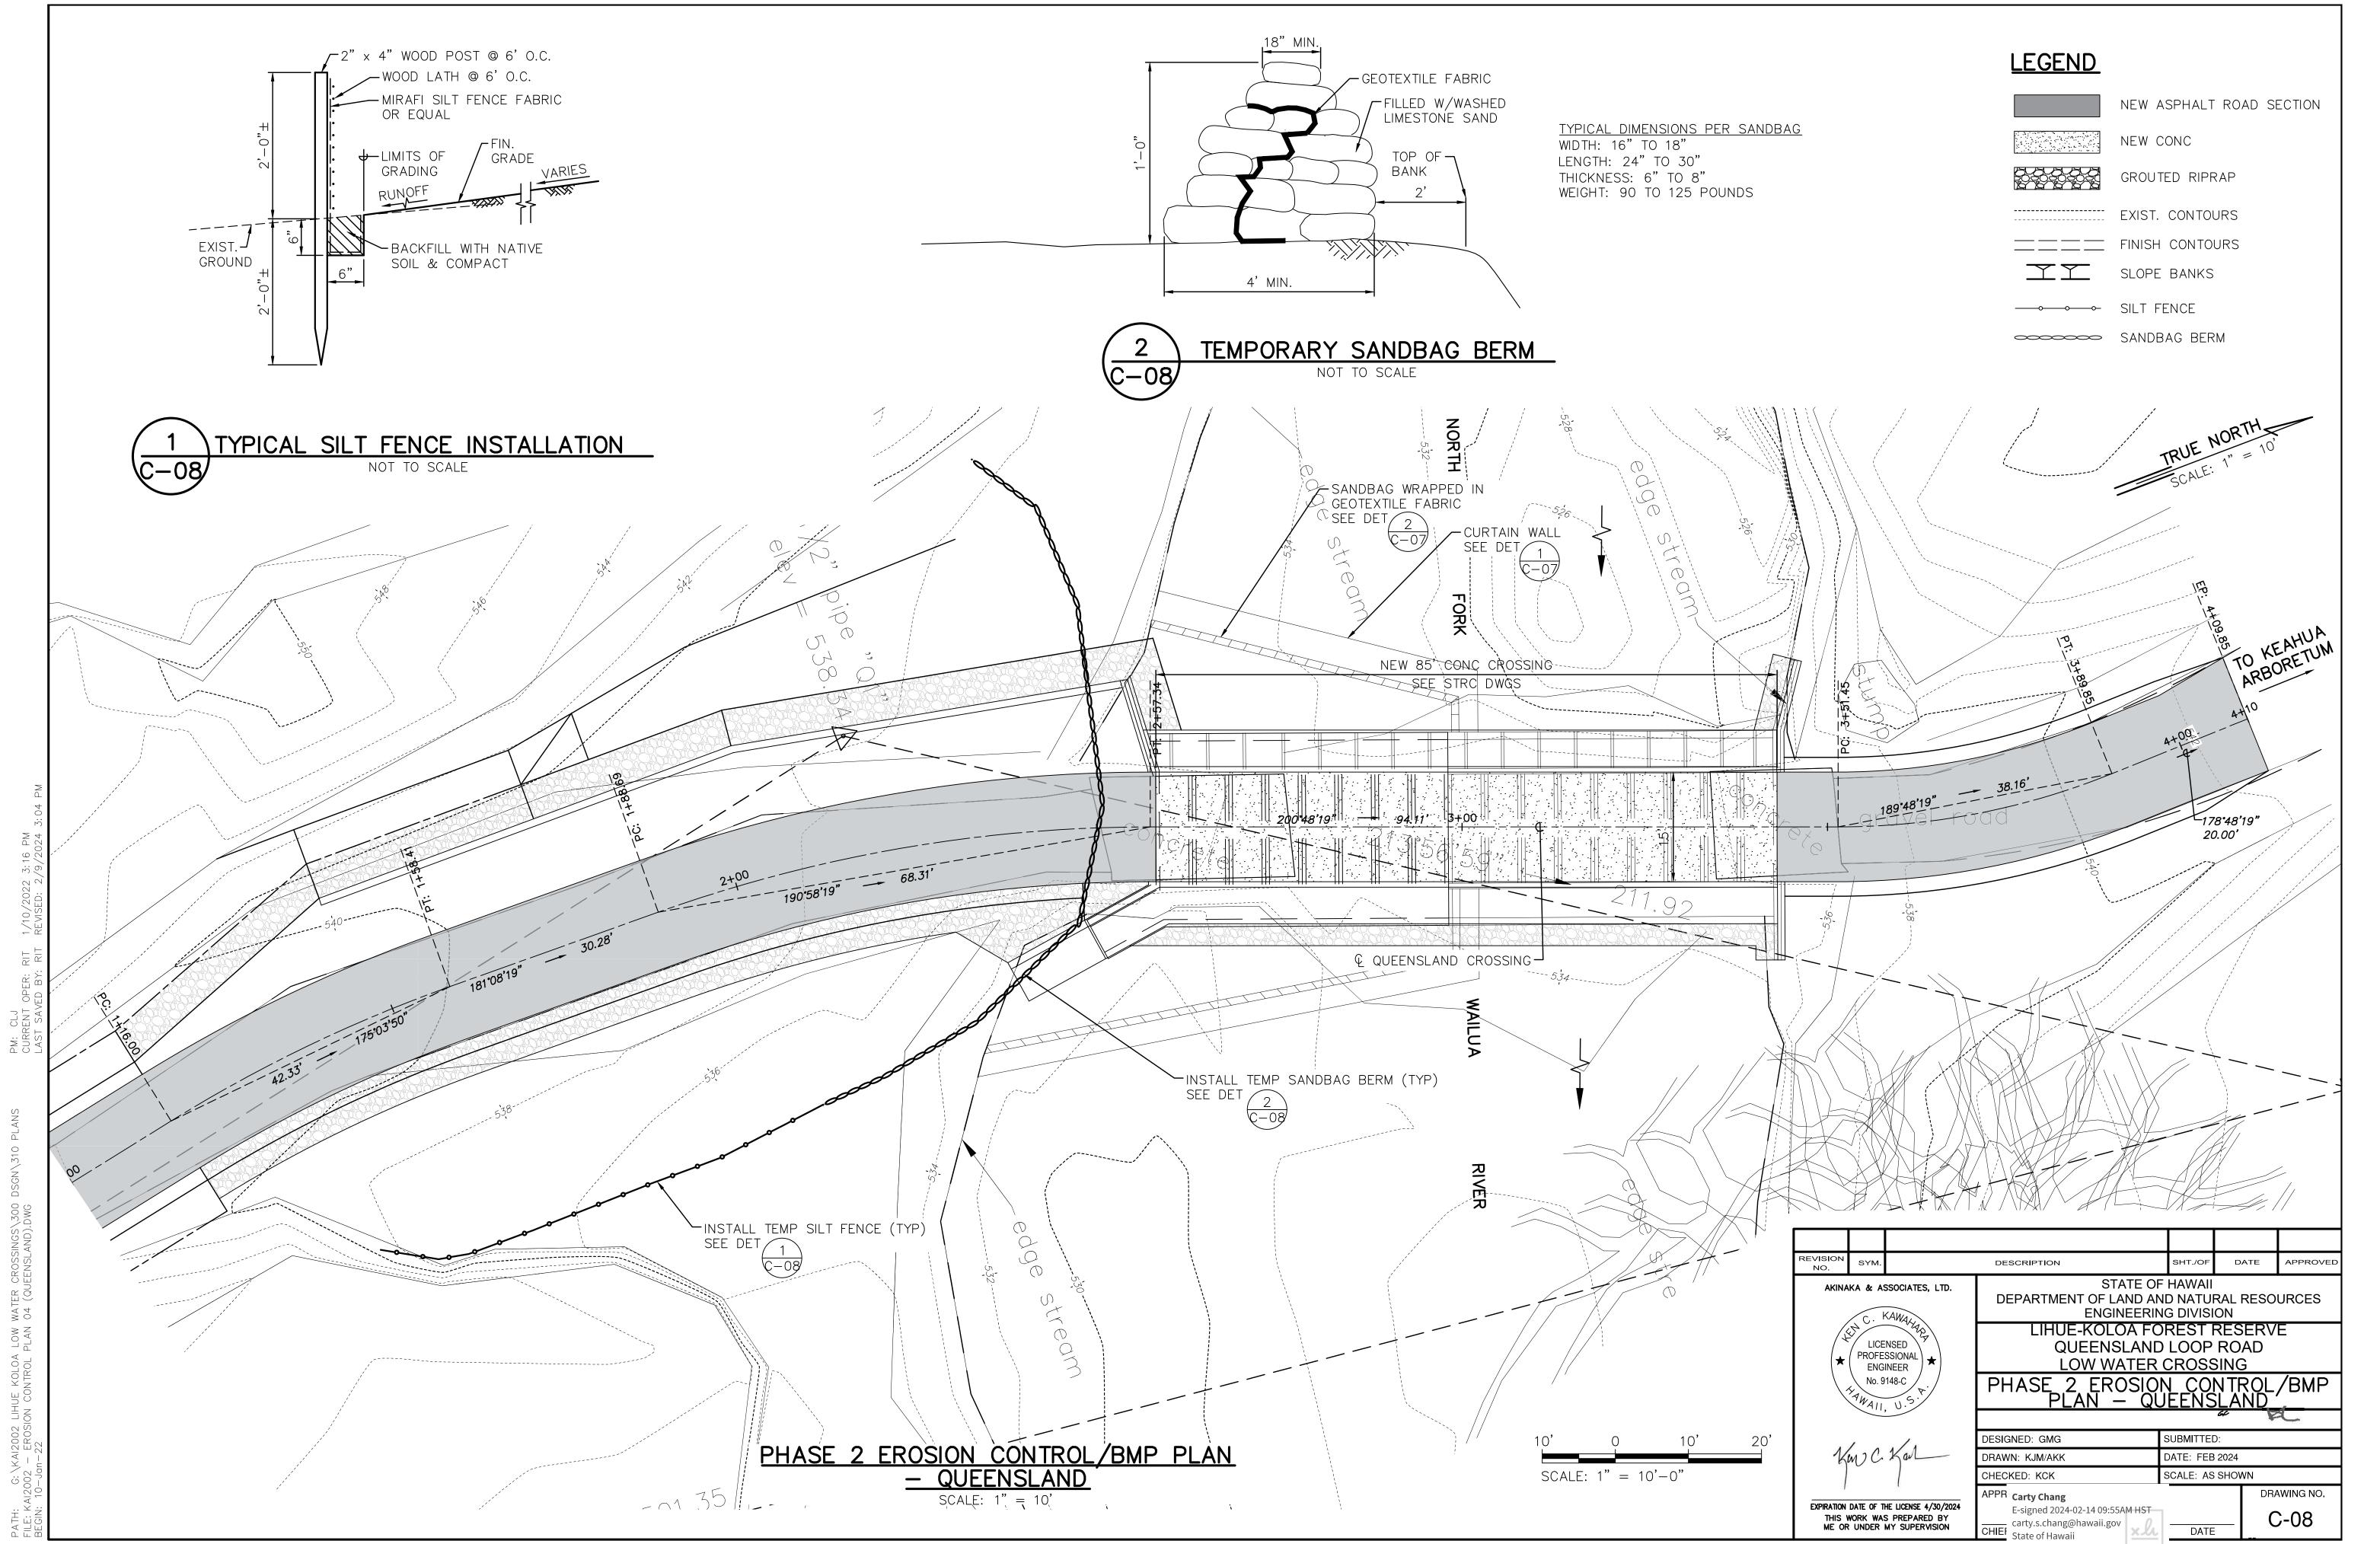

Chief Engineer SHEET NO. 9 OF 18 SHEETS

GENERAL: A. WORKMANSHIP AND MATERIALS SHALL CONFORM TO THE AASHTO LRFD BRIDGE DESIGN SPECIFICATION, 9TH EDITION, 2020 INCLUDING ITS SUBSEQUENT INTERIM SPECIFICATIONS, AND THE HAWAII STANDARD SPECIFICATIONS FOR BRIDGE AND ROAD	C. TETRAGUARD AS20 SHRINKAGE REDUCING ADMIXTURE, ECLIPSE PLUS SHRINKAGE RE EQUAL, SHALL BE INCLUDED IN THE CONCRETE MIX FOR THE CONCRETE TOPPING A DOSAGE SHALL BE 128 OUNCES PER CUBIC YARD OF CONCRETE OR AS RECOMMEN ADDITION OF SHRINKAGE REDUCING ADMIXTURE SHALL BE AS RECOMMENDED BY T				
CONSTRUCTION, 2005 AS MODIFIED BY THE STATE OF HAWAII DEPARTMENT OF TRANSPORTATION. B. THE CONTRACTOR SHALL COMPARE THE CIVIL AND STRUCTURAL DRAWINGS WITH EACH OTHER AND REPORT IN WRITING TO	D. A CORROSION INHIBITING ADMIXTURE SHALL BE INCLUDED IN THE CONCRETE MIX FO INHIBITING ADMIXTURE SHALL CONTAIN A MINIMUM OF 30% CALCIUM NITRATE BY M				
THE ENGINEER, INCONSISTENCIES OR OMISSIONS. C. THE CONTRACTOR SHALL TAKE FIELD MEASUREMENTS AND VERIFY FIELD CONDITIONS AND SHALL COMPARE SUCH FIELD MEASUREMENTS AND CONDITIONS WITH THE DRAWINGS BEFORE COMMENCING THE WORK. REPORT IN WRITING TO THE ENCINEER, ALL INCONSISTENCIES, OR OMISSIONS.	DOSAGE RATE OF 4.0 GALLONS PER CUBIC YARD OF CONCRETE OR AS RECOMMEN ADMIXTURE SHALL BE RHEOCRETE CNI CALCIUM NITRATE-BASED CORROSION INHIBI AN APPROVED EQUAL. ADDITION OF CORROSION INHIBITING ADMIXTURE SHALL BE A MANUFACTURER.				
ENGINEER ALL INCONSISTENCIES OR OMISSIONS. D. THE CONTRACTOR SHALL BE RESPONSIBLE FOR METHODS OF CONSTRUCTION, WORKMANSHIP AND JOB SAFETY. THE CONTRACTOR SHALL PROVIDE TEMPORARY SHORING AND BRACING AS REQUIRED FOR STABILITY OF STRUCTURAL MEMBERS AND SYSTEMS.	D. ALL INSERTS, ANCHOR BOLTS, PLATES, ETC. EMBEDDED IN CONCRETE SHALL BE HONOTED.				
E. DETAILS NOTED AS TYPICAL ON STRUCTURAL DRAWINGS SHALL APPLY IN ALL CONDITIONS UNLESS SPECIFICALLY SHOWN OR NOTED OTHERWISE.	E. CONSTRUCTION JOINTS MAY BE RELOCATED BY THE CONTRACTOR AND SUBMITTED CONSTRUCTION JOINTS SHALL BE MADE AND RELOCATED AS NOT TO IMPAIR THE S MINIMIZE SHRINKAGE STRESSES. ALL CONSTRUCTION JOINTS SHALL BE CLEANED, TYPICAL DETAILS FOR SPECIFIC REQUIREMENTS.				
F. THE CONTRACTOR SHALL BE RESPONSIBLE FOR COORDINATING THE WORK OF ALL TRADES.					
G. THE CONTRACTOR SHALL BE RESPONSIBLE FOR PROTECTION OF THE ADJACENT PROPERTIES, STRUCTURES, STREETS, AND UTILITIES DURING THE CONSTRUCTION PERIOD. ANY DAMAGE OR DETERIORATED PROPERTY SHALL BE RESTORED TO THE SAME OR BETTER CONDITION AT NO COST TO THE STATE.	<ul> <li>F. UNLESS OTHERWISE NOTED, CHAMFER ALL CONCRETE EDGES 3/4".</li> <li>G. CONCRETE DELIVERY TICKETS SHALL RECORD ALL FREE WATER IN THE MIX: AT BABY DRIVER, AND ANY ADDITIONAL REQUEST BY CONTRACTOR IF PERMITTED BY THE DESCRIPTION OF THE DESCRIPTO</li></ul>				
DEMOLITIONS NOTES:	H. REINFORCING BARS, ANCHOR BOLTS, INSERTS AND OTHER ITEMS TO BE CAST IN TH				
A. THE CONSTRUCTION DRAWINGS INDICATE THE GENERAL EXTENT OF REQUIRED DEMOLITION AND REMOVAL WORK.	POSITION PRIOR TO PLACEMENT OF CONCRETE.				
B. THE CONTRACTOR SHALL FIELD VERIFY EXISTING CONDITIONS (PRIOR TO BID) TO DETERMINE THE EXTENT OF ALL REQUIRED DEMOLITION WORK. THE REMOVAL OR DEMOLITION OF MATERIALS, ACCESSORIES, FIXTURES, ETC.,	REINFORCING STEEL:				
SHALL BE COMPLETE AND INCLUDE ALL RELATED ITEMS TO THE EXTENT THAT FUTURE CONSTRUCTION CAN BE PERFORMED AND COMPLETED WITHOUT ADDITIONAL COST TO THE STATE.	A. REINFORCING STEEL SHALL BE DEFORMED BARS CONFORMING TO ASTM A615, GRAD				
C. ALL NECESSARY PRECAUTIONS SHALL BE TAKEN TO INSURE AGAINST DAMAGE TO EXISTING ITEMS AND FEATURES REMAINING IN PLACE.	B. CLEAR CONCRETE COVERAGE FOR REINFORCING BARS SHALL BE AS FOLLOWS, UNL				
D. THE CONTRACTOR SHALL REMOVE EXISTING ITEMS AS DEEMED NECESSARY SO THAT FUTURE WORK CAN BE	a. FOOTING CAST AGAINST EARTH 3"				
PERFORMED AND ALSO, SO THAT ANY EXISTING ITEM IS NOT DAMAGED WHEN FUTURE WORK IS PERFORMED. THE CONTRACTOR SHALL ALSO INSTALL ANY OR ALL OF THE ITEMS, PATCH AND RESTORE SURROUNDING	b. FOOTING FORMED AND EXPOSED TO EARTH 2"				
SURFACES AS REQUIRED AS PART OF THE WORK ACCEPTABLE TO THE CONTRACTING OFFICER.	c. WALL FACES EXPOSED TO EARTH OR WEATHER 2"				
E. LOCATION OF UNDERGROUND UTILITIES AND PIPES SHOWN ON THE PLANS ARE APPROXIMATE ONLY. THE CONTRACTOR SHALL VERIFY THE EXACT LOCATIONS OF THE EXISTING UTILITIES AND SHALL BE RESPONSIBLE FOR ANY DAMAGES TO THEM. ANY PORTION OF THE EXISTING UTILITIES THAT MUST BE REMOVED OR	C. STAINLESS STEEL REINFORCING BARS SHALL BE TYPE 316 GRADE CONFORMING TO				
OTHERWISE DISTURBED TO ACCOMPLISH THIS WORK CALLED FOR ON THE PLANS SHALL BE RECONSTRUCTED, REPLACED OR RESTORED TO THE ORIGINAL CONDITION AT THE CONTRACTOR'S OWN EXPENSE.	D. SPLICES:				
	a. REINFORCING STEEL SHALL BE SPLICED ONLY WHERE INDICATED ON PLANS.				
DESIGN CRITERIA:	FIBER REINFORCED POLYMER STRUCTURAL MEMBERS:				
<ul> <li>A. DEAD LOAD WEIGHT OF ALL COMPONENTS OF THE STRUCTURES, APPURTENANCES ATTACHED THERETO, AND EARTH COVERS.</li> <li>B. LIVE LOAD HL-93 TRUCK</li> <li>C. LATERAL EARTH PRESSURE</li> </ul>	A. FIBER-REINFORCED PLOYMER STRUCTURAL SHAPES SHALL BE MANUFACTU FROM A NON-FLAME RETARDANT ISOPHTHALIC POLYESTER RESIN SYSTEM. MINIMUM TENSILE AND COMPRESSIVE STRESS IN THE LENGTHWISE DIRECTIO MINIMUM FLEXURAL STRESS LENGTHWISE OF 30 KSI (ASTM D790) AND A M KSI.				
ACTIVE CONDITION, ABOVE GROUNDWATER= 35 PCF ACTIVE CONDITION, BELOW GROUNDWATER= 65 PCF AT REST CONDITION= 65 PCF	B. ALL BOLTED CONNECTIONS FOR FRP MEMBERS SHALL BE WITH STAINLESS ASTM F593.				
D. HYDRAULIC LOADS 100-YEAR EVENT	C. INSTALL BEAMS WITH ANY CROWN IN MEMBER ORIENTED UPWARD.				
VELOCITY= 3.8 FT/S^2 HEIGHT= 5'-9" FROM STREAMBED	D. STAINLESS STEEL WEDGE ANCHORS SHALL HAVE A CURRENT ICC ES REPO PER PRODUCTS ICC ES REPORT.				
FOUNDATION: A. FOUNDATION DESIGN IS BASED UPON GEOTECHNICAL INVESTIGATIONS BY HART CROWSER AND DATED AUGUST 19, 2021.	E. MEMBERS SHALL BE INSTALLED IN A MANNER THAT WILL ALLOW THEM TO REMOVING BOLTS, AND NO EXTRAORDINARY EFFORT.				
B. CONTRACTOR SHALL PROVIDE FOR DESIGN AND INSTALLATION OF ALL CRIBBING, SHEETING, AND SHORING NECESSARY FOR PERSONNEL SAFETY AND TO PRESERVE EXCAVATIONS AND EARTH BANKS, AND ADJACENT STRUCTURES AND PROPERTY FOR DAMAGE.	STRUCTURAL STEEL:				
C. EXCAVATION BOUNDARIES AND GRADE ELEVATIONS FOR FOOTING SHALL BE APPROVED BY THE ENGINEER PRIOR TO PLACING THE CONCRETE AND REINFORCING.	A. FABRICATION AND ERECTION OF STRUCTURAL STEEL SHALL CONFORM TO CONSTRUCTION MANUAL OF STEEL CONSTRUCTION, THIRTEENTH EDITION.				
<ul> <li>D. BACKFILL BEHIND THE RETAINING STRUCTURES (ABOVE THE GROUNDWATER LEVEL) MAY CONSIST OF THE ON-SITE SOILS</li> <li>OR SELECT GRANULAR FILLS (TYPE A STRUCTURE BACKFILL). BACKFILL SHALL BE PLACED IN UNIFORM LIFTS OF NO MORE</li> </ul>	B. STAINLESS STEEL ROLLED FLAT BARS, HOT ROLLED OR EXTRUDED STRUCT TEES, CHANNELS, OR BEAMS SHALL CONFORM TO ASTM A276.				
THAN 8 INCHES IN LOOSE THICKNESS AND UNIFORMLY COMPACTED TO AT LEAST 95 PERCENT RELATIVE COMPACTION. BECAUSE SHALLOW GROUNDWATER CONDITIONS ARE ANTICIPATED, BACKFILL MATERIALS BELOW THE GROUNDWATER LEVEL SHOULD CONSIST OF FREE-DRAINING GRANULAR MATERIALS, SUCH AS AASHTO M43, NO 67 GRADATION (ASTM C33, NO	C. WELDS AND WELDING PROCEDURES SHALL CONFORM TO THE STRUCTURAL AMERICAN WELDING SOCIETY.				
67 GRADATION), WRAPPED ON ALL SIDES WITH NON—WOVEN FILTER FABRIC (MIRAFI 180N OR EQUIVALENT). THE FREE—DRAINING GRANULAR MATERIALS SHOULD BE USED UP TO A LEVEL OF ABOUT 12 INCHES ABOVE THE	D. WELDING SHALL BE PERFORMED BY WELDERS PREQUALIFIED FOR WELDING				
GROUNDWATER LEVEL TO FACILITATE COMPACTION OF THE BACKFILL MATERIALS.	E. WELDING ELECTRODES SHALL BE E70XX FOR CARBON STEEL. FOR STAINLI BE COMPATIBLE WITH MATERIAL WELDED PER AWS STANDARDS.				
A. CONCRETE SHALL BE NORMAL WEIGHT HARD ROCK CONCRETE AND SHALL HAVE 4000 PSI MINIMUM 28-DAY COMPRESSIVE STRENGTHS.	F. STAINLESS STEEL BOLTS SHALL CONFORM TO ASTM F593, TYPE 316, AND F594, TYPE 316.				
B. ALL CONCRETE SHALL HAVE MAXIMUM W/C RATIO OF 0.45 EXCEPT FOR CLASS "A" WHICH SHALL BE AS SPECIFIED IN THE STANDARD SPECIFICATIONS.	G. STAINLESS STEEL THREADED RODS SHALL CONFORM TO ASTM A193, GRAD				

REDUCING ADMIXTURE, OR AN APPROVED G AND BRIDGE RAILING. THE REQUIRED IENDED BY THE MANUFACTURER. THE MANUFACTURER.

FOR ALL CONCRETE. THE CORROSION MASS AND SHALL BE ADDED AT A ENDED BY THE MANUFACTURER. THE IBITOR, DCI S CORROSION INHIBITOR OR E AS RECOMMENDED BY THE

HOT-DIP GALVANIZED UNLESS OTHERWISE

) TO THE ENGINEER FOR APPROVAL. STRENGTH OF THE STRUCTURE AND TO , LAITANCE REMOVED AND WETTED. SEE

BATCHING BY PLANT, FOR CONSISTENCY THE MIX DESIGN.

THE CONCRETE SHALL BE SECURED IN

ADE 60 UNLESS OTHERWISE NOTED.

INLESS OTHERWISE NOTED:

O ASTM A955 GRADE 60.

URED BY THE PULTRUDED METHOD THE MEMBERS SHALL HAVE A ION OF 30 KSI (ASTM D638), A MODULUS OF ELASTICITY OF 2,800

S STEEL BOLTS IN CONFORMANCE WITH

PORT. ANCHORS SHALL BE INSTALLED

) BE REMOVED IN THE FUTURE BY

THE AMERICAN INSTITUTE OF STEEL

CTURAL SHAPES, SUCH AS ANGLES,

L WELDING CODE AWS D1.1 OF THE

G PROCEDURES TO BE USED.

NLESS STEEL FILLER MATERIAL SHALL

) STAINLESS STEEL NUTS TO ASTM


ADE B8.


### PRECAST CULVERT:

- A. LOCATION OF LIFTING DEVICES FOR THE PRECAST CULVERT SHOULD BE DESIGNED BY PRECAST MANUFACTURER.
- B. THE LIFTING HOLES SHALL BE FILLED WITH EPOXY NON-SHRINK GROUT.
- C. REINFORCING STEEL SHALL EXTEND FILL WIDTH OF END WALL PROVIDING 3" CLEARANCE.
- D. ANY SPACE BETWEEN ADJACENT BOXES TO BE FILLED WITH GROUT.


REVISION NO.	SYM.		DESCRIPT	ION	SHT./OF	DATE	APPROVED
<i>l</i> i		URJAL	DEPAR	STATE O TMENT OF LAND A ENGINEERII	ND NATU	RAL RESC	OURCES
G CO PROFESSIONAL ENGINEER No. 11475−S			LIHU'E-KOLOA FOREST RESERVE QUEENSLAND LOOP ROAD LOW WATER CROSSING				
FAWAII, U.S.P.		STRUCTURAL NOTES					
		GC EL					
			DESIGNED:	CS	SUBMITTE	D: CS	
0	• 1		DRAWN:	CAD	DATE:	OCT 202	3
Sall	r fe	Daufalali	CHECKED:	SP	SCALE:	AS SHO	WN
EXPIRATION THIS V	DATE OF TI	HE LICENSE 4/30/2024 S PREPARED BY MY SUPERVISION		24-02-14 09:55AM HST g@hawaii.gov	DATE		awing no. <b>S-1</b>
	JOB I	NO. D00AK67B	Chiof Engine		10 OF	18 SHE	ETS

I	MINIMUM SPLICE AND EMBEDMENT LENGTHS					db 12db	
	CONCRETE STRENGTH = 4,000 PSI LAP SPLICE DEVELOPMENT						
	BAR SIZE	TOP BARS	OTHER BARS	STRA OTHER BARS		WITH STANDARD HOOK	<u>90° BEND</u>
:	#3	29"	21"	12"	17"	10"	Kaba
	#4	29" 36"	21" 26"	12" 15"	17" 21"	10" 12"	
	#5 #6	43"	31"	18"	26"	12	<u>135° BEND</u>
	#7 #9	54"	39"	23"	32"	18"	
	#8 #9	71" 90"	51" 64"	30" 38"	42 <b>"</b> 53"	20" 22"	$\sqrt{-1}$ 4db OR
	<b>#</b> 10	114"	81"	48"	67"	26"	≠ 2½" MIN
	#11	140"	100"	59"	82"	28"	180° BEND SPLICE
							LENGTH 6" (MIN)
							IN CONTACT WIRE TOGETHER
							BAR LAP
							D = 6d <sub>b</sub> FOR #8 AND SMALLER D = 8d <sub>b</sub> FOR #9 TO #11
	TYP	ICAL	. REE	BAR S	SPLI		
	DEV	'ELO	PME	NT L	ENG	TH S	CHEDULE
2	NOT TO	) SCALE					
			/ FL/	ASHING CO	MPOUND		30'-0" MAX 30'-0" MAX
			/	TERPROOF		CES OF L OCCURS	
		/	/	E 1/4:1			FLASHING COMPOUND
				- '/ '' '	1/3		FACES OF WALLS WHERE CENTER 12 BACKFILL OCCURS THRU-OUT
	•	<u>/</u>	•	•			
		ے لے 					
	•	• •	•	•	, M		
:ON	「FACE —				1/3		FRONT FACE
							2" TYP. STOP ALL VERT. CONTROL JOIN
			1" A	T SLAB			HORIZ. REINF. AT ON EACH FACE OF
			11/4"	AT WALLS T FOOTING	ç		JUINT AS SHOWN TOP OF FOOTING
	<b>DCT</b> · ··						
	<u> KF LUN</u>	<u>ning WAL</u>	<u>L CONS</u>	IKUCTION	<u>i joint</u>		JOINT MAY BE FORMED WITH 1/8" MASONITE
							AND CUT BACK TO THE ROOT OF THE
						Ŧ	CHAMFER ON THE EXPOSED FACE
		"T" / A OF	1	SEE PLAN SPACING.	SPACE	$\rightarrow$	WALL FACE
	1" MIN DE			EVENLY BE		TS	
		FILLED WIT RIC SEALA	1				34" CHAMFER
	"	•			•		RETAINING WALL CONTROL JOIN
	* <del>\</del>	 	·/./././.	· / · / · / · / · /	<u> / . ]</u>	NOT	
	NCRETE -	· / · / · / ·	·/././././	/ . / . / . / . / . / . / . / . / . /		1. S	AW CUTTING SHALL OCCUR AS SOON AS CONCRETE SURFACE IS
CO	AB-ON-GF	RADE					TRM ENOUGH TO NOT BE TORN BY CUTTING BLADE AND BEFORE SHRINKAGE CRACKING OCCURS, BUT NO LATER THAN 12 HOURS
			CONCTDI	JCTION J	<u>OINT</u>		AFTER CONCRETE HAS BEEN POURED. INLESS NOTED OTHERWISE SUBMIT JOINTING PLANS FOR REVIEW.
		<u>SLAB</u>				•	· · · · · · · · · · · · · · · · · · ·
		<u>SLAB</u>					
		<u>SLAB</u>					
	<b>T</b> \/ <b>D</b>				<b></b> ^ -		
SL,			. JOII		ETA	ILS	

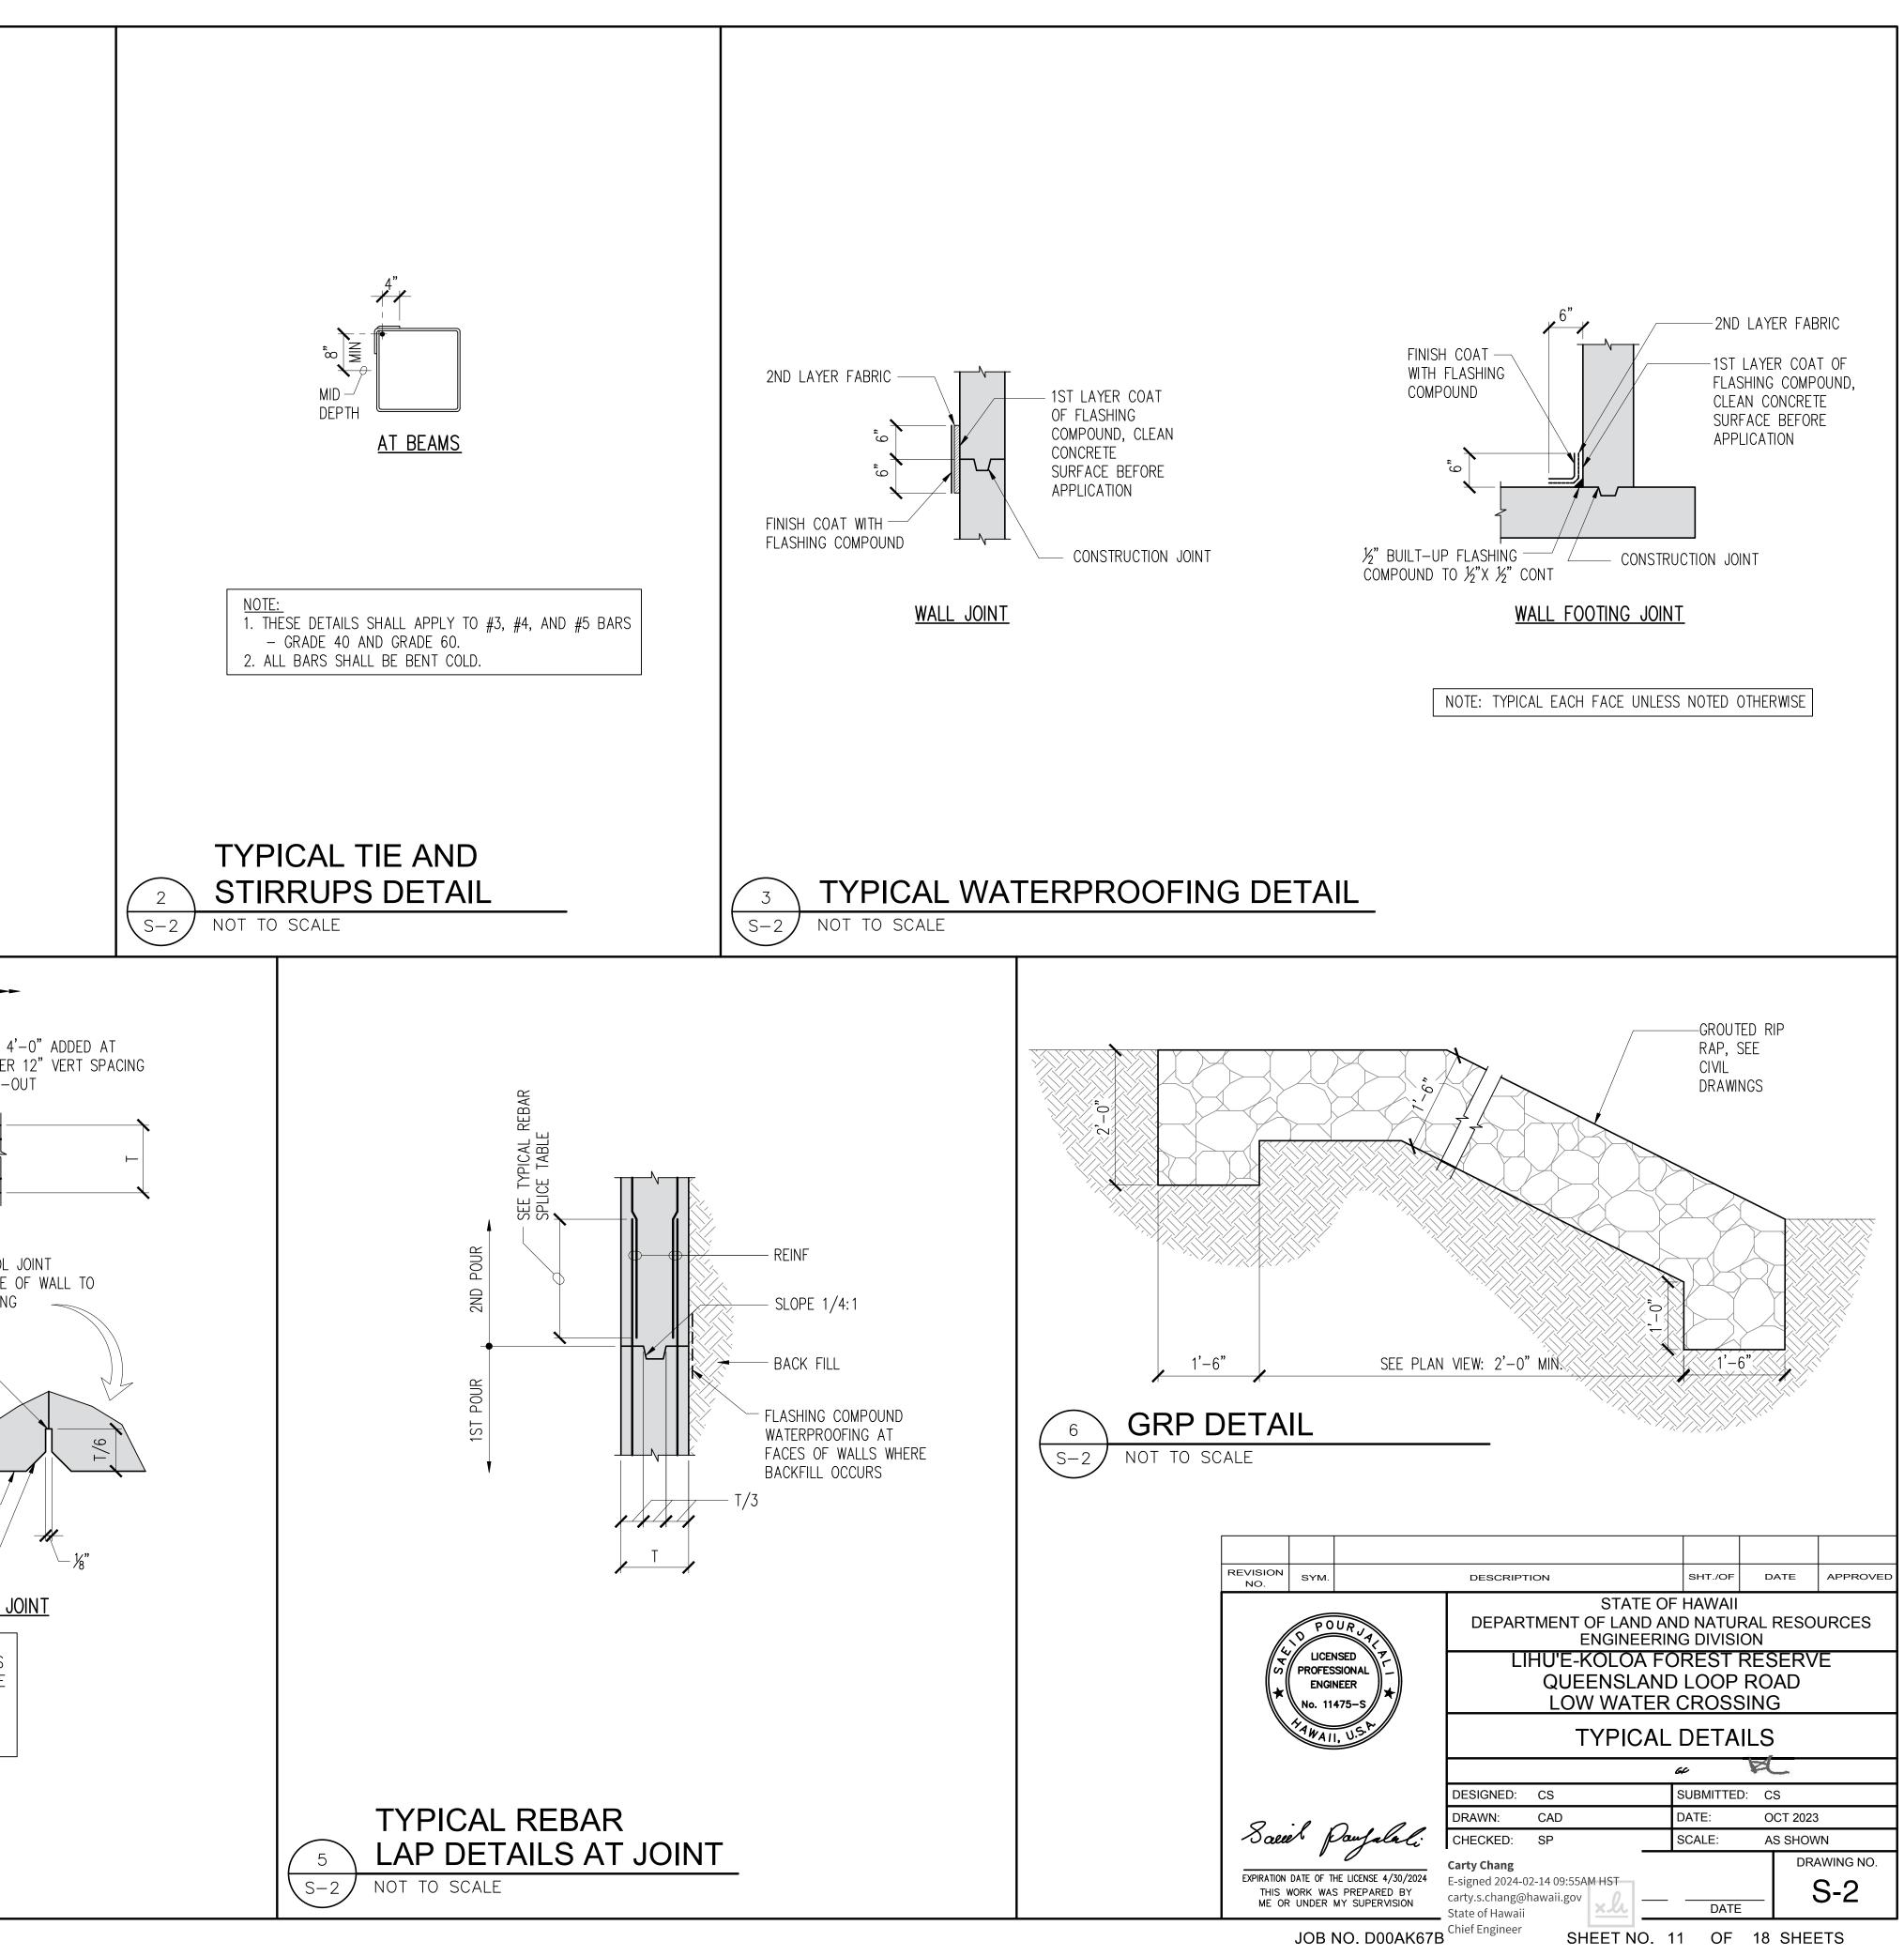

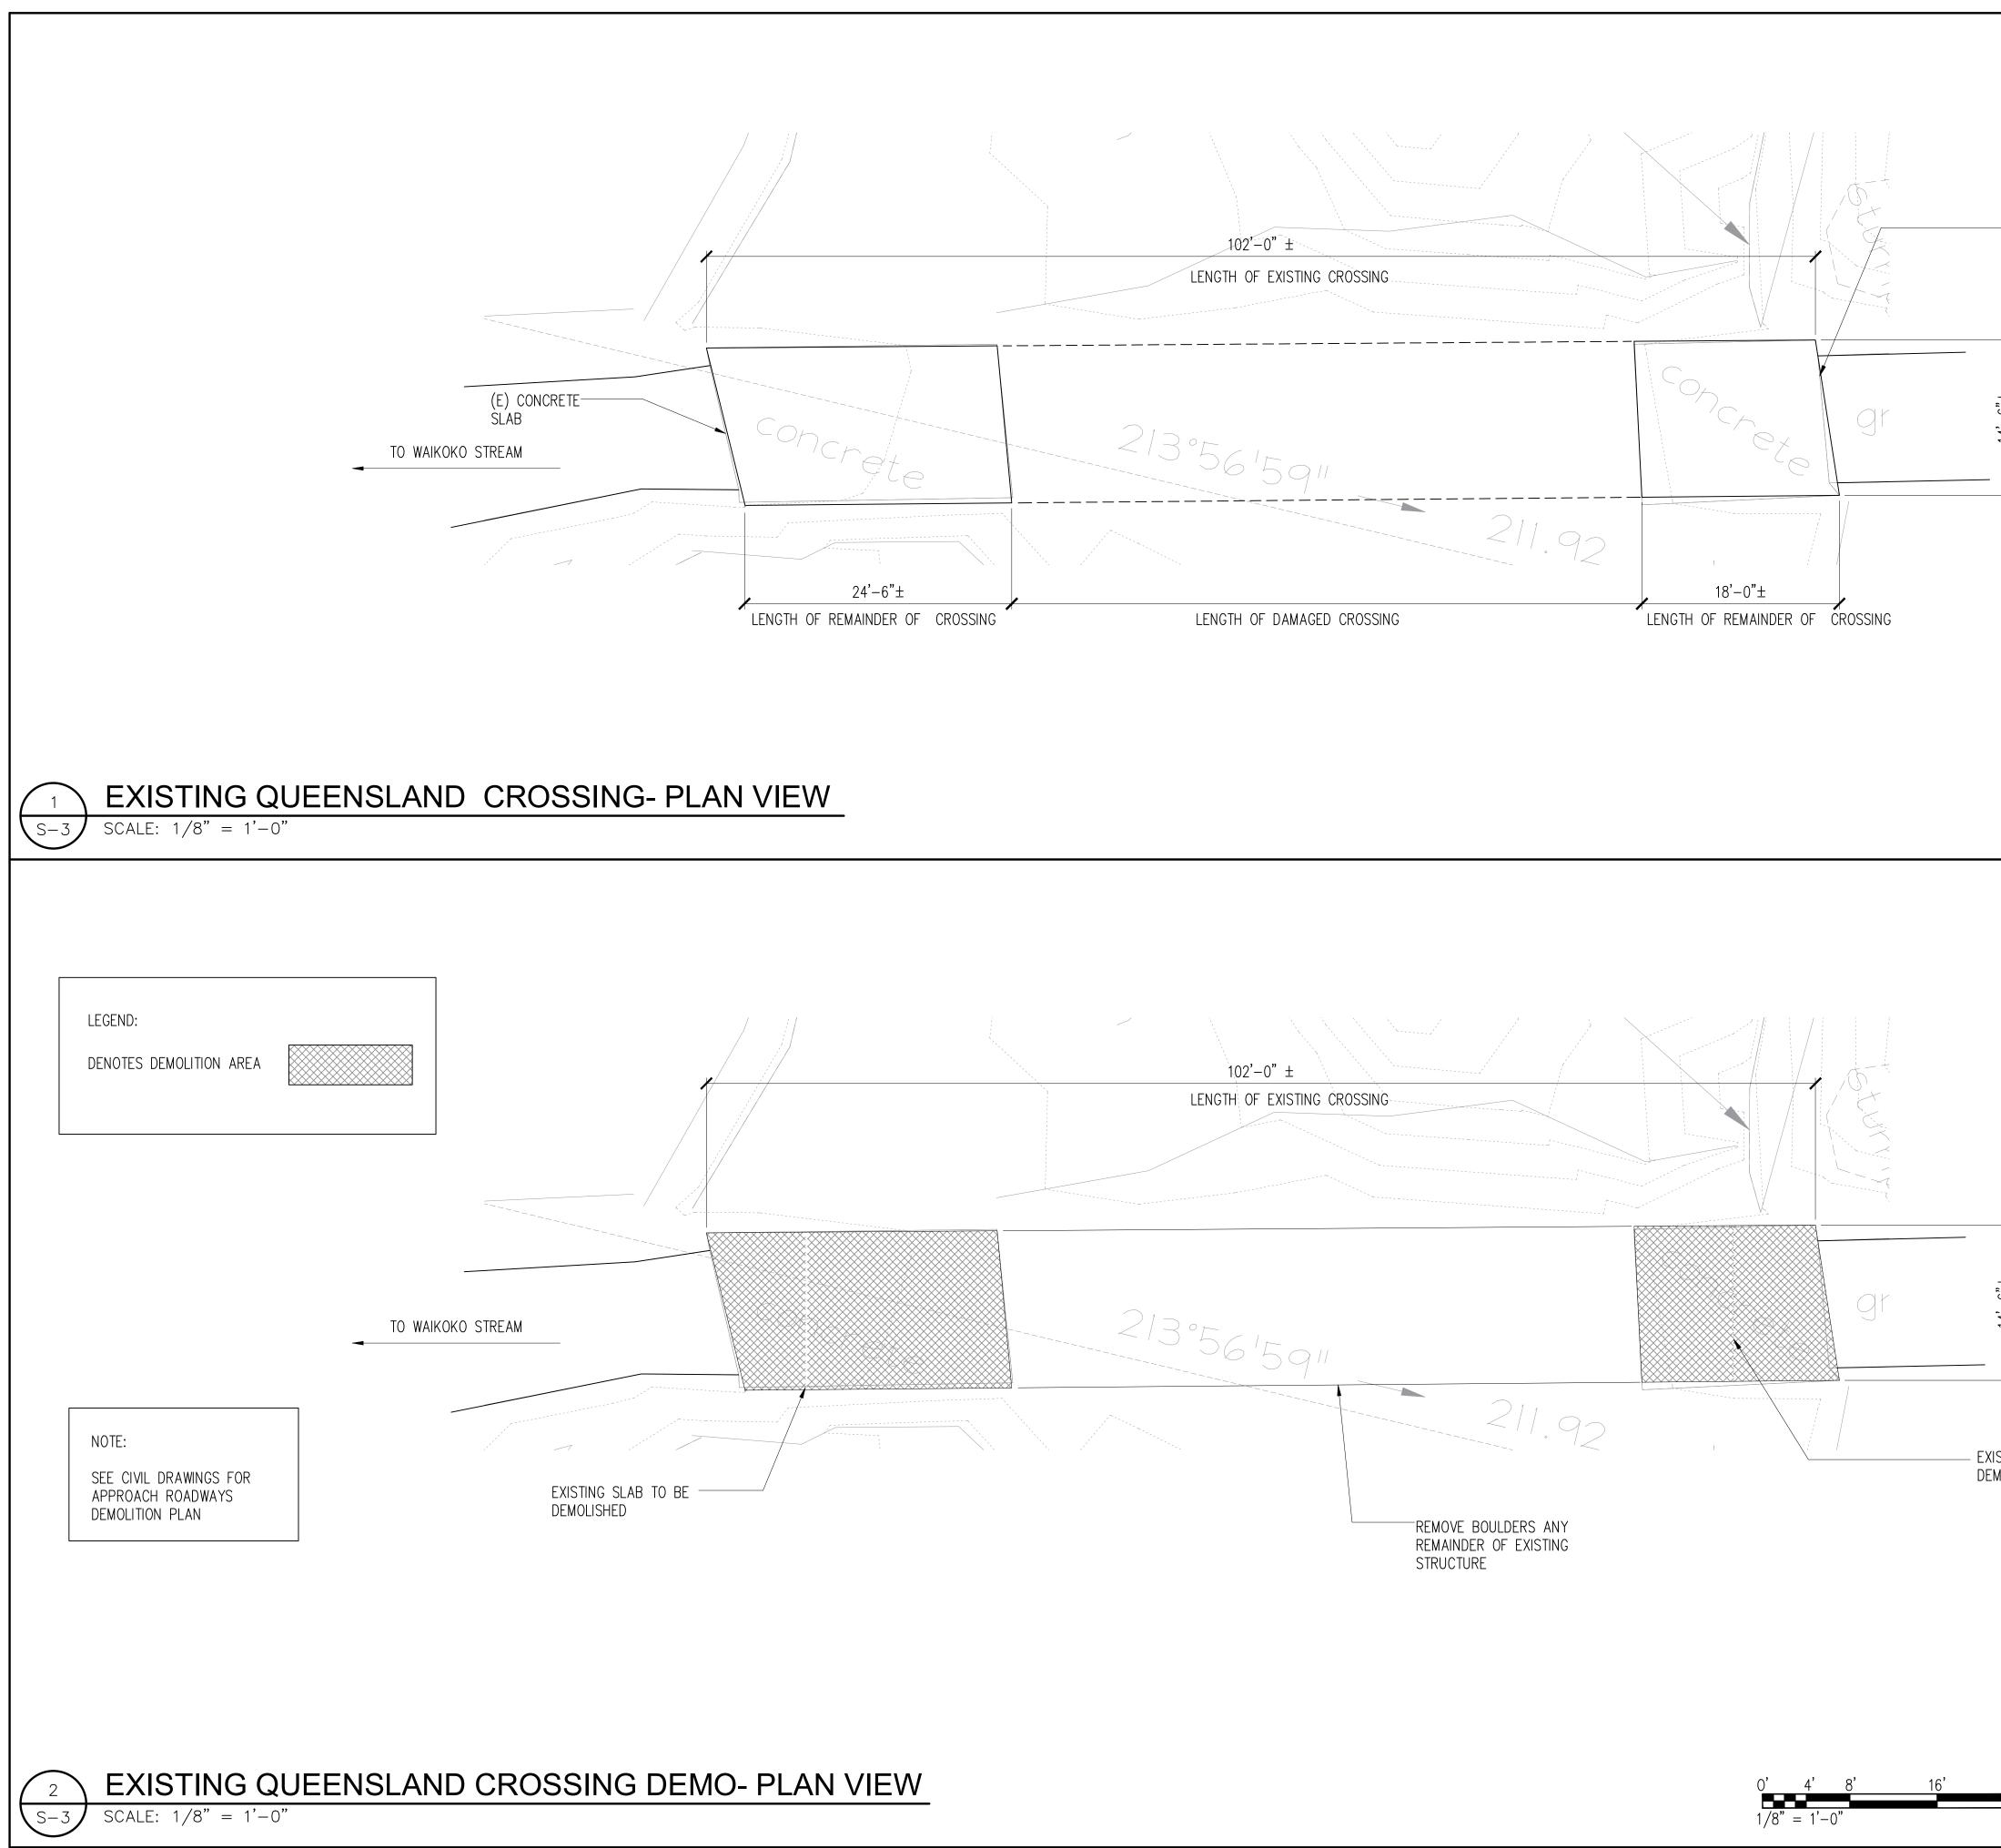


— (E) CONCRE SLAB	ETE		
WIDTH OF EXISTING CROSSING	TO KEAHUA ARBORETUM		
		${}$ $SCALE : 1/8" = 1'-0$	
		TRUE NORTH	
WIDTH OF EXISTING CROSSING	TO KEAHUA ARBORETUM	TRUE NORTH $SCALE : 1/8" = 1'-0$	
THE THE STING SLAB TO			
TING SLAB TO		SCALE : 1/8" = 1'-0 DESCRIPTION SHT./OF DATE APPROX	VED
TING SLAB TO	) BE	SCALE : 1/8" = 1'-0	
TING SLAB TO	BE REVISION SYM. NO. POUR JAT POUR JAT PROFESSIONAL ENGINEER No. 11475–S	SCALE : 1/8" = 1'-0         DESCRIPTION         STATE OF HAWAII         DEPARTMENT OF LAND AND NATURAL RESOURCES         ENGINEERING DIVISION         LIHU'E-KOLOA FOREST RESERVE         QUEENSLAND LOOP ROAD         LOW WATER CROSSING	
STING SLAB TO	BE REVISION SYM. NO. POUR JAT POUR JAT PROFESSIONAL ENGINEER No. 11475–S	SCALE : 1/8" = 1'-0         DESCRIPTION         STATE OF HAWAII         DEPARTMENT OF LAND AND NATURAL RESOURCES         ENGINEERING DIVISION         LIHU'E-KOLOA FOREST RESERVE         QUEENSLAND LOOP ROAD         LOW WATER CROSSING         QUEENSLAND CROSSING DEMO PLA         ØUEENSLAND CROSSING DEMO PLA	

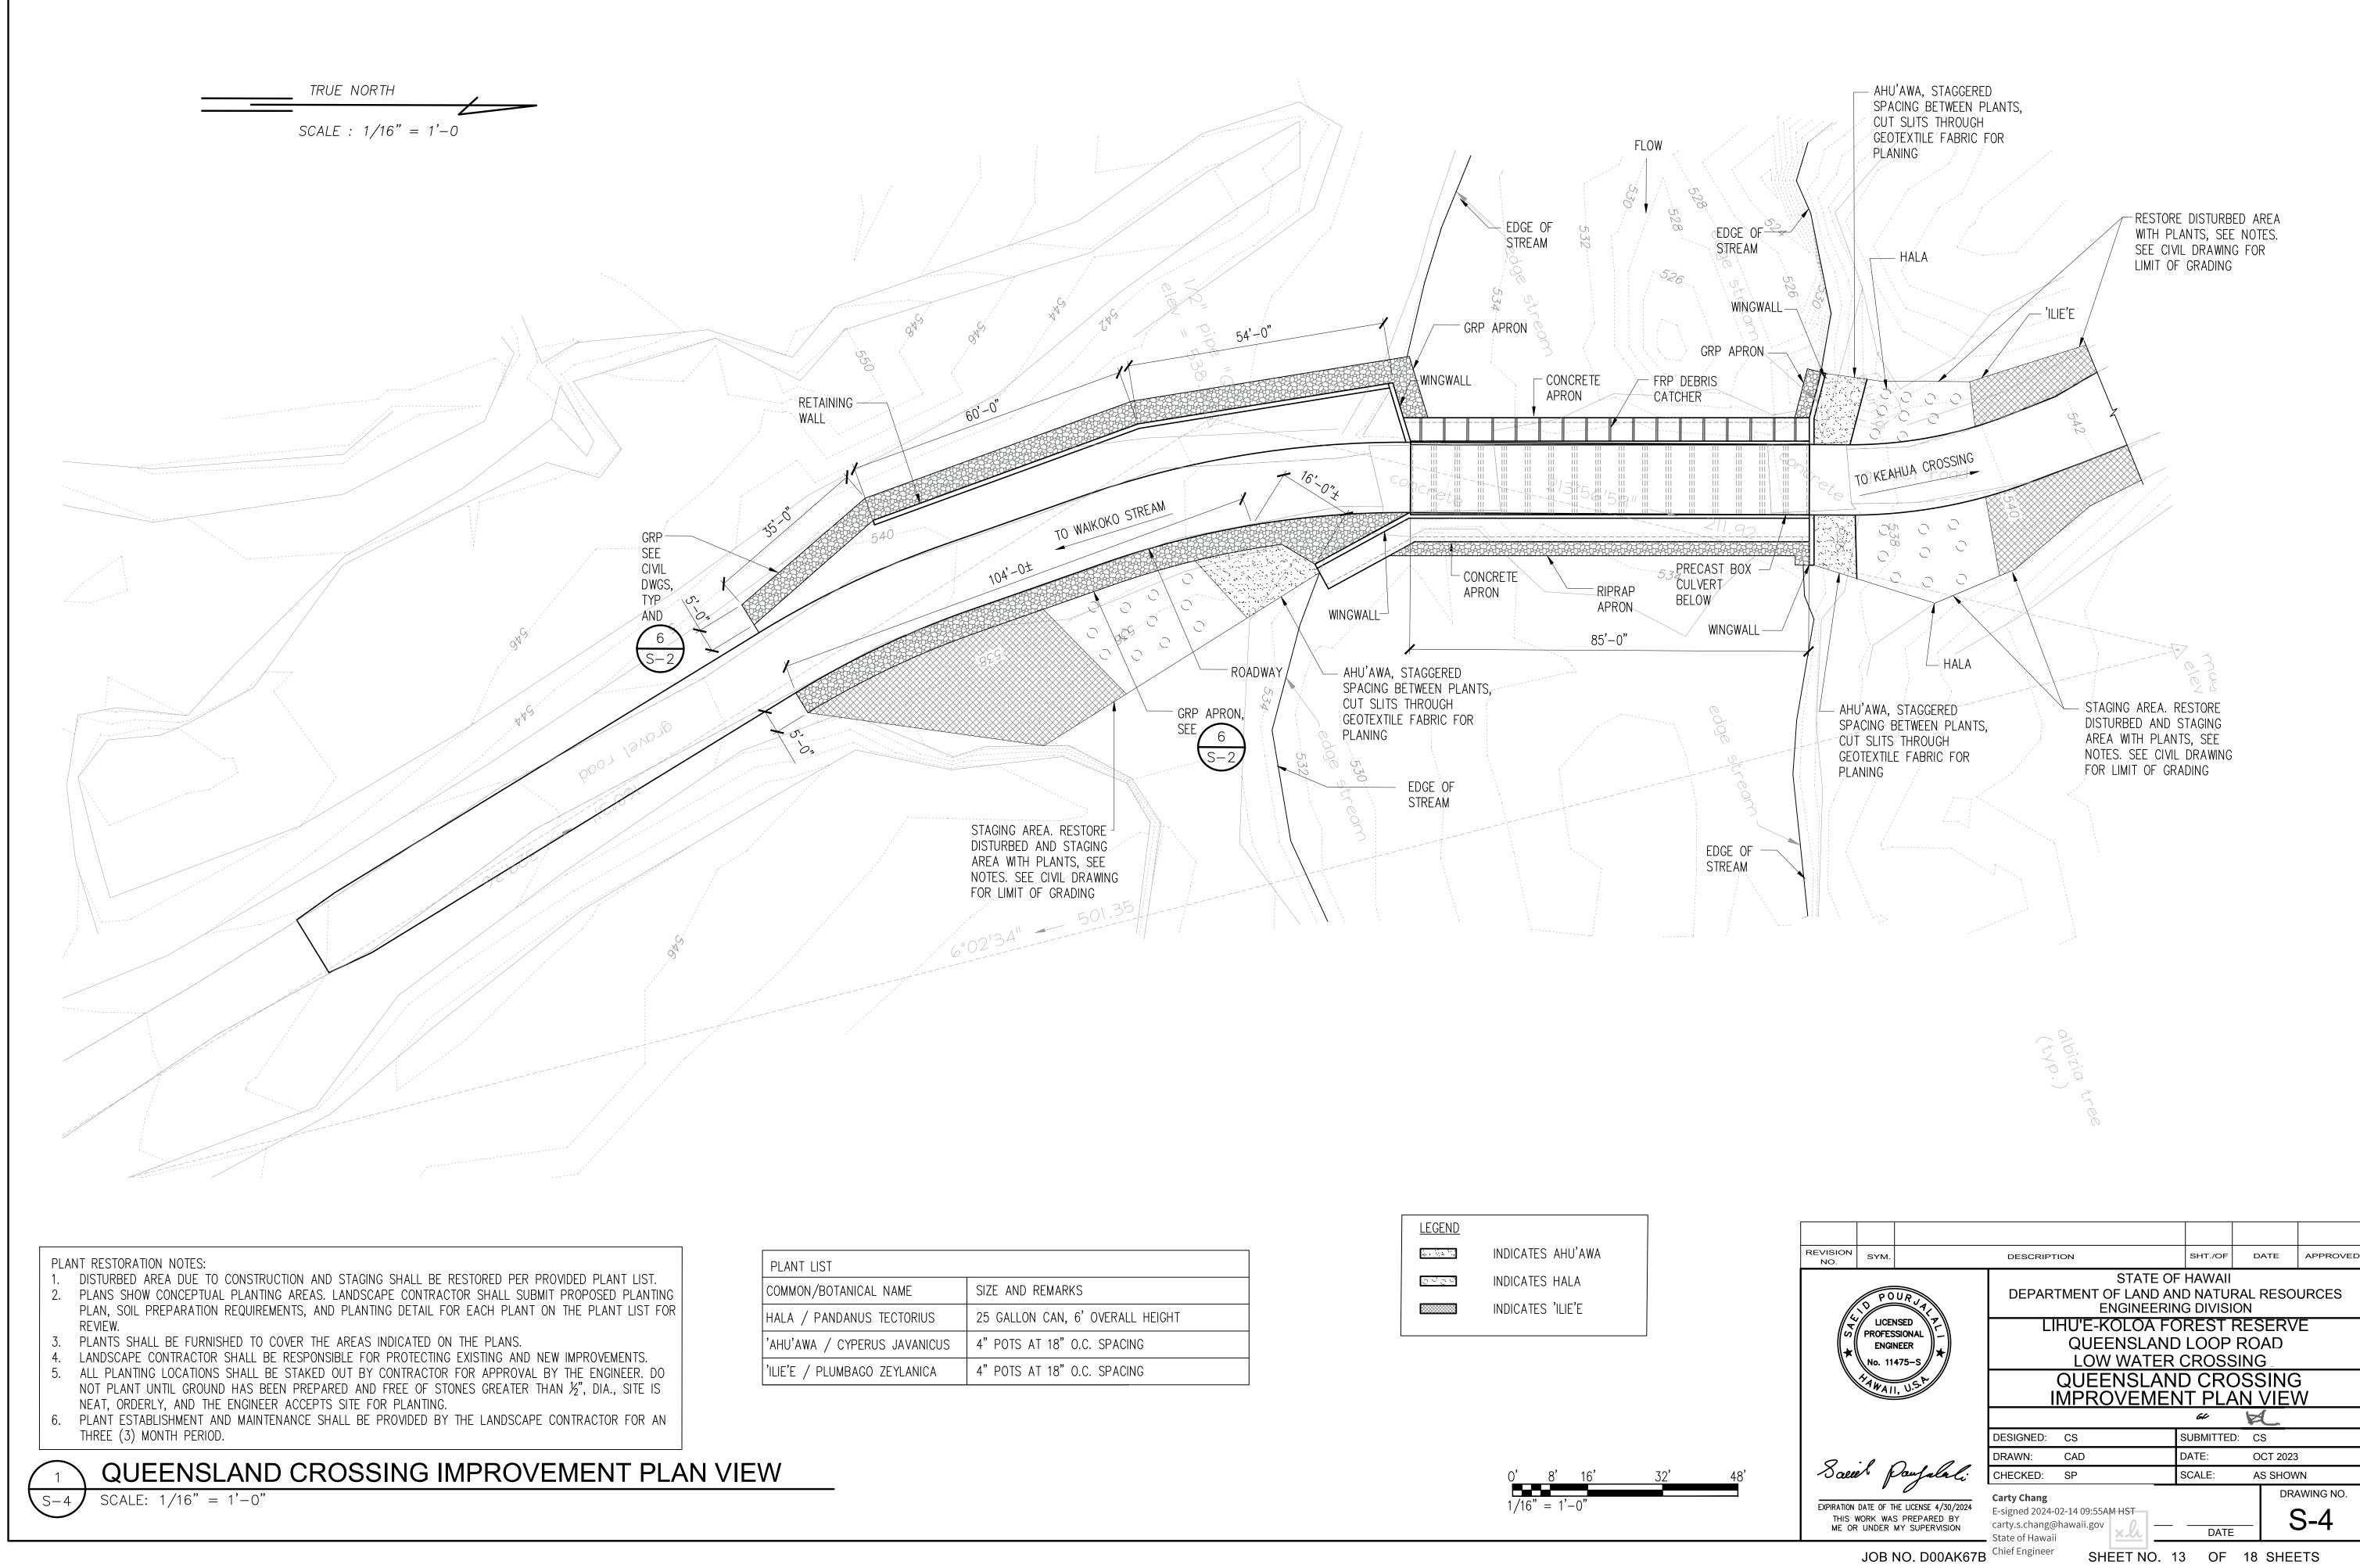


LANT LIST	
MMON/BOTANICAL NAME	SIZE AND REMARKS
ala / Pandanus tectorius	25 GALLON CAN, 6' OVERALL HEIGHT
HU'AWA / CYPERUS JAVANICUS	4" POTS AT 18" O.C. SPACING
ie'e / plumbago zeylanica	4" POTS AT 18" O.C. SPACING


LEGEND	
	INDICATES AHU'AWA
0000	INDICATES HALA
	INDICATES 'ILIE'E


SHEET NO. 13 OF 18 SHEETS

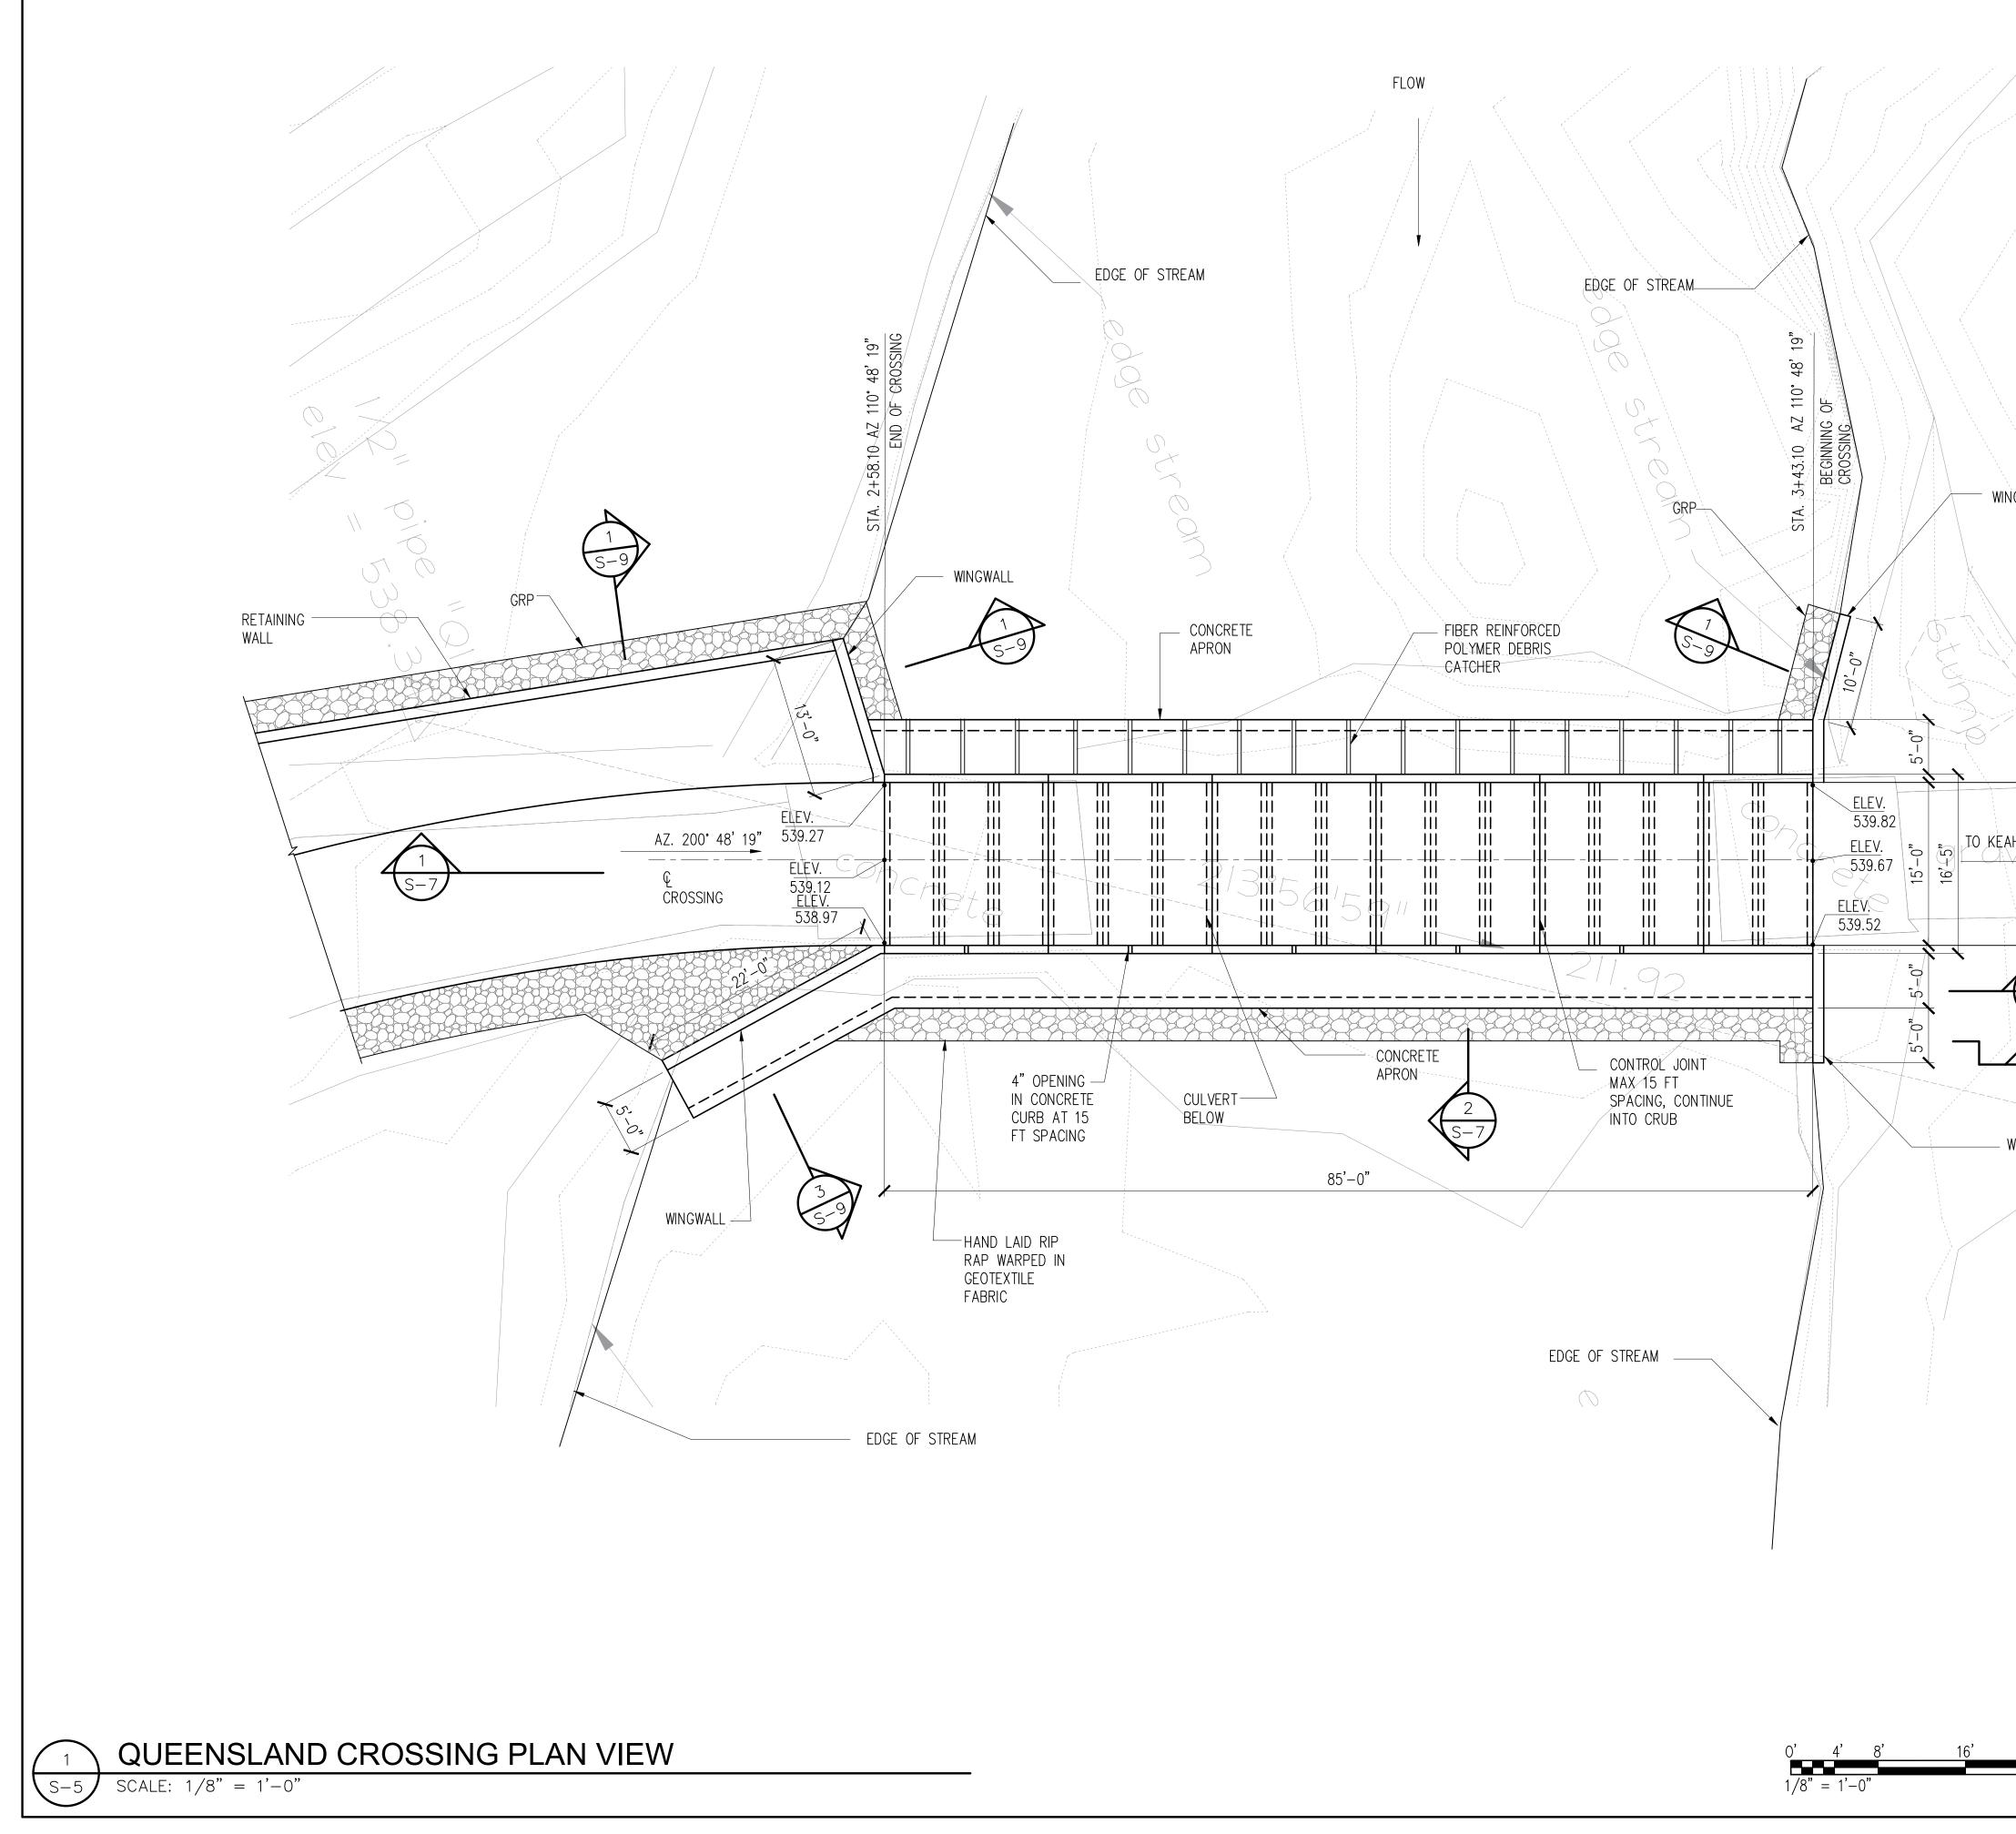



	TRUE NORTH	
	SCALE : 1/8"	= 1' - 0
GWALL		
ROADWAY		
Y		
.3		
HUA_CROSSING		
$\widehat{\boldsymbol{A}}$		
$\begin{pmatrix} 2\\ S-9 \end{pmatrix}$		
4		
<u>S-9</u>		
INGWALL		
NO. SYM.	DESCRIPTION	SHT./OF DATE APPROVED
D POUR JA	DEPARTMENT OF LAND AI	ND NATURAL RESOURCES
	LIHU'E-KOLOA FO	OREST RESERVE
★ ENGINEER No. 11475-S ★	QUEENSLANI LOW WATER	D LOOP ROAD CROSSING
AMAIL, U.S.M	QUEENSLAND (	CROSSING PLAN
		a K
	DESIGNED: CS DRAWN: CAD	SUBMITTED: CS DATE: OCT 2023
24' Saeiel Paufalali	CHECKED: SP	SCALE: AS SHOWN
EXPIRATION DATE OF THE LICENSE 4/30/2024 THIS WORK WAS PREPARED BY	Carty Chang E-signed 2024-02-14 09:55AM HST	DRAWING NO.
ME OR UNDER MY SUPERVISION	carty.s.chang@hawaii.gov	DATE
JOB NO. D00AK67B	SHEET NO. 1	14 OF 18 SHEETS

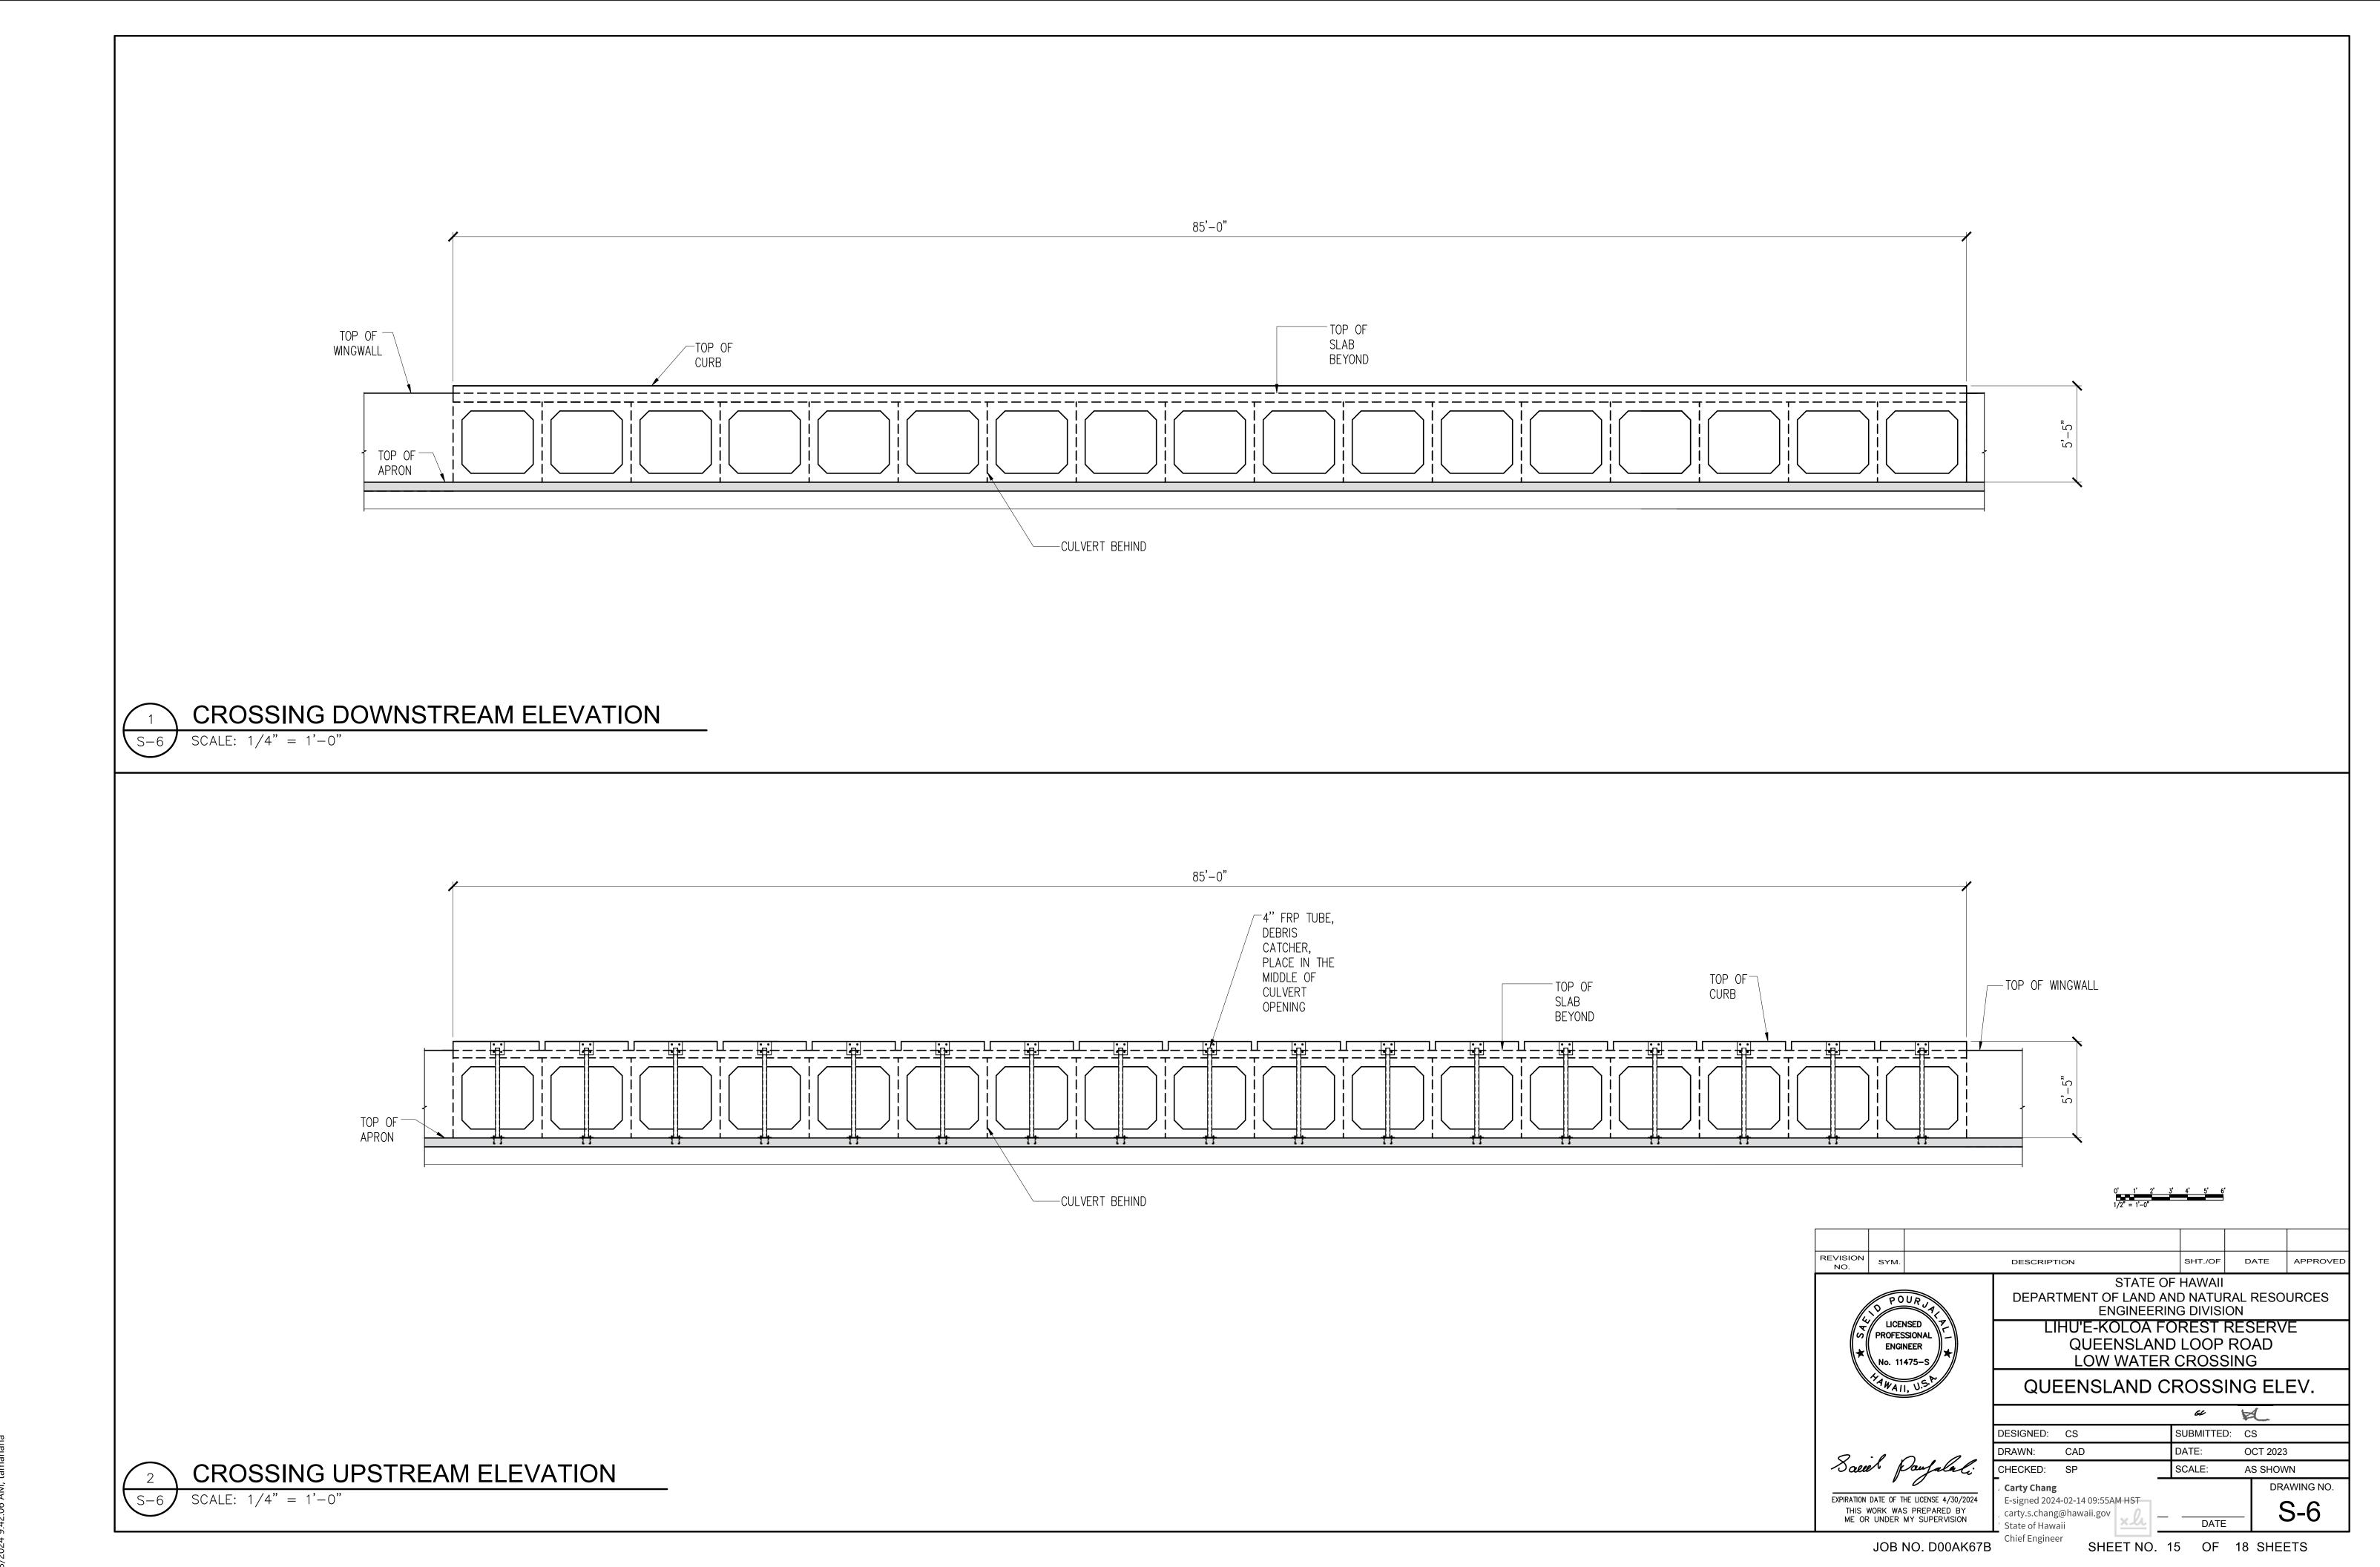

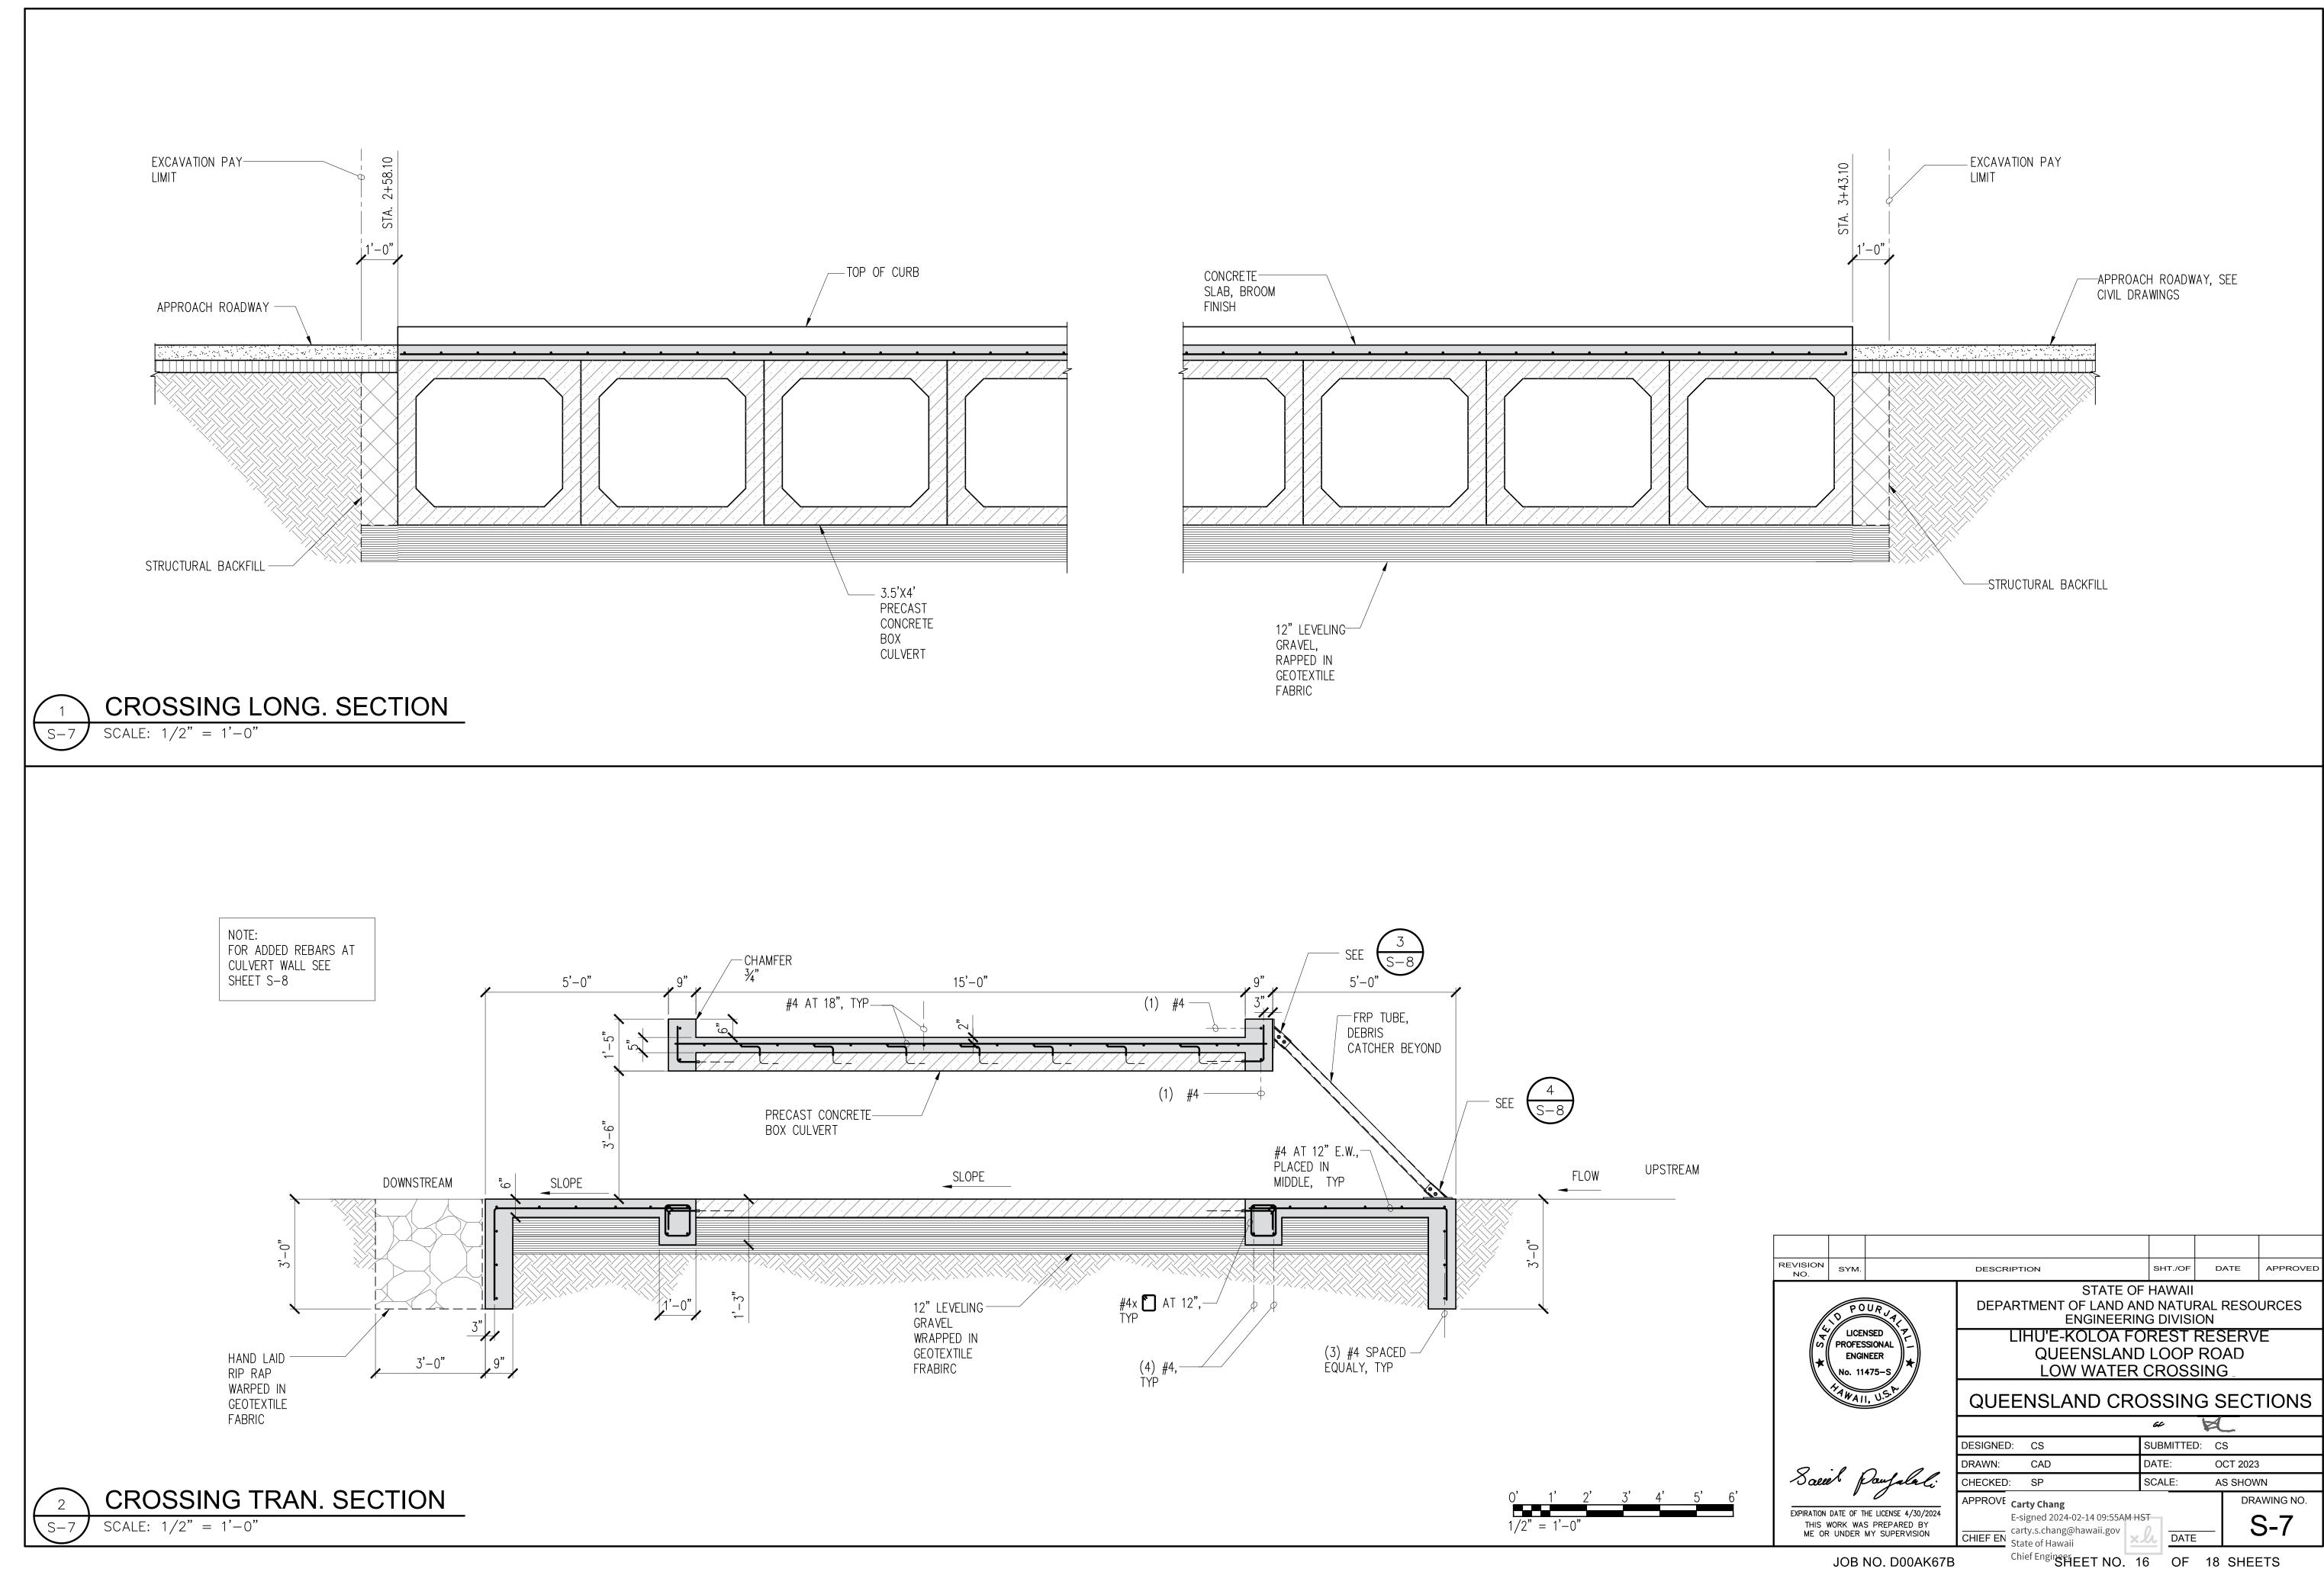

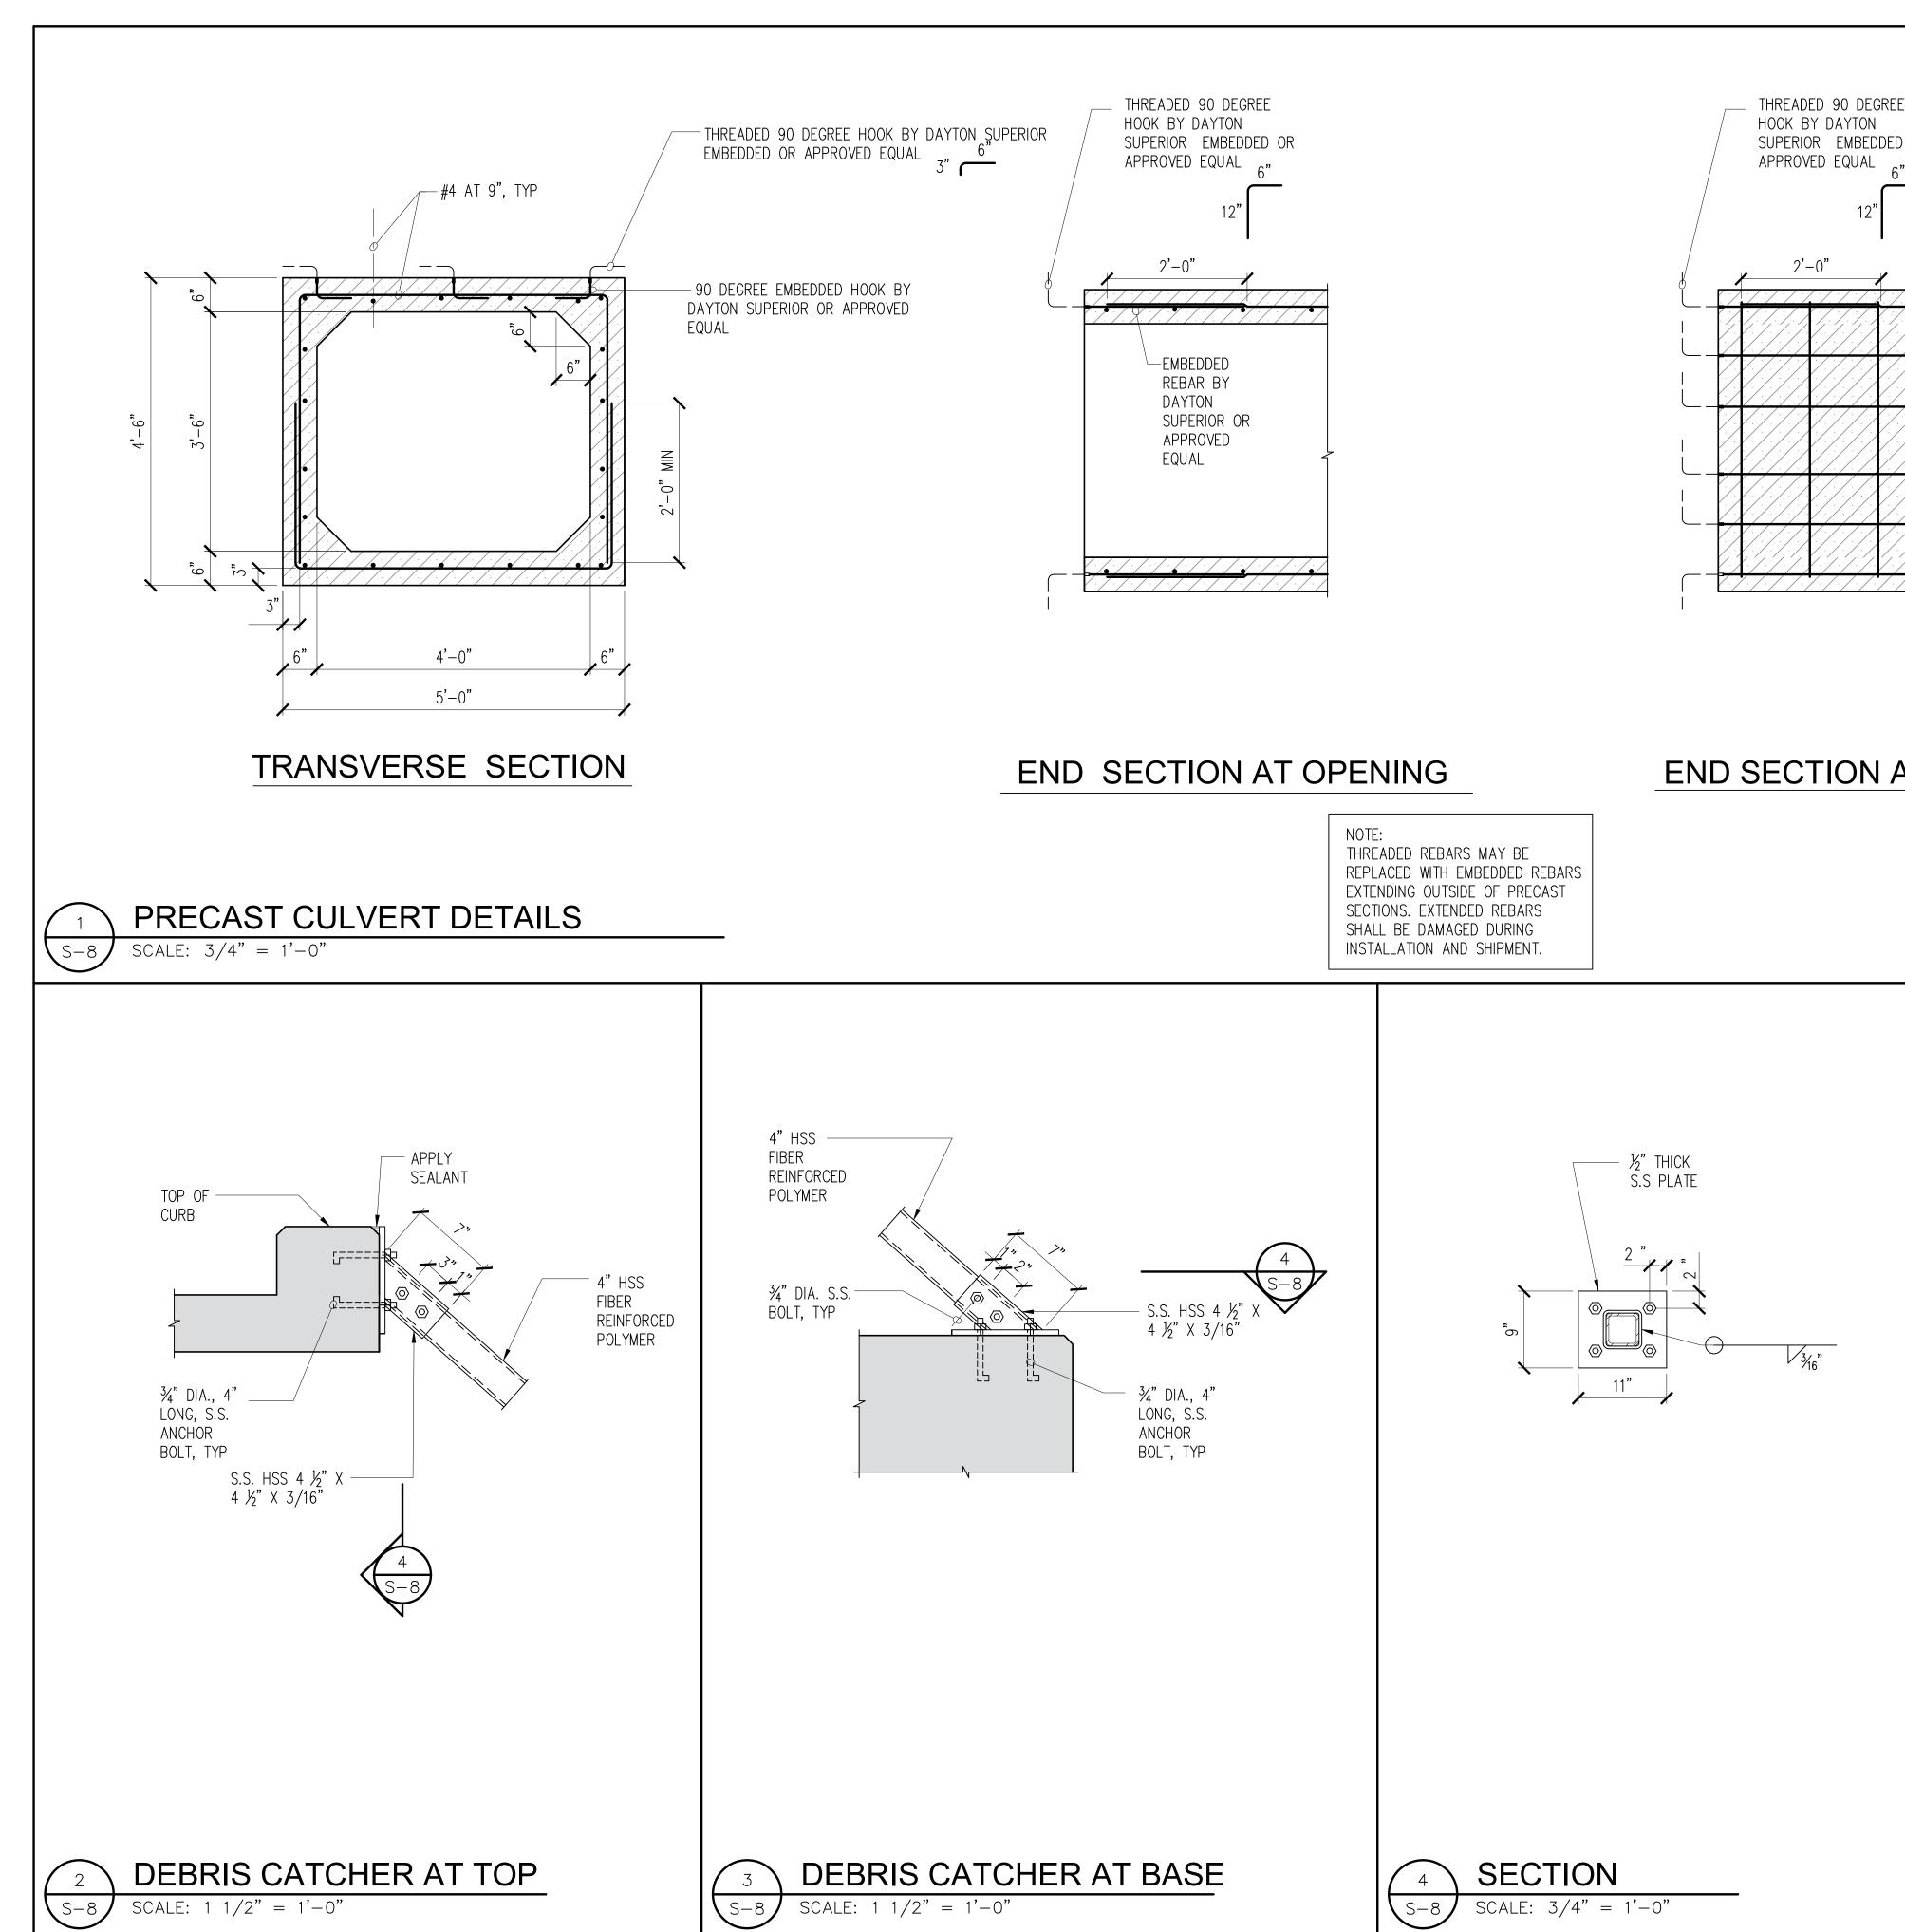

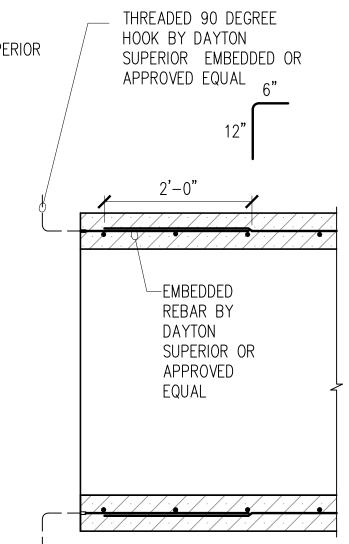

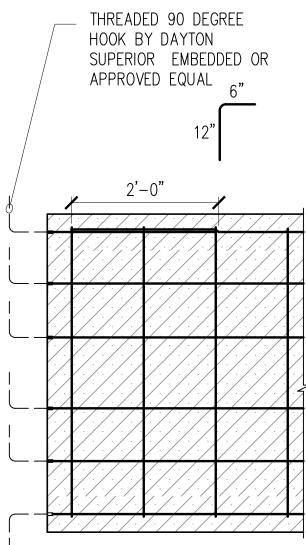

## END SECTION AT WALL

